#### **AGENDA**

Board of Zoning Appeals / Planning Commission Meeting Tuesday, May 9, 2023 - 6:00pm

#### Pre-agenda @ 5:30pm

- □ Call to Order
- □ Roll Call
- □ Approval of Agenda May 9, 2023
- □ Approval of Board of Zoning Appeals/Planning Commission Minutes

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  □ Approval of Board of Zoning Appeals/Planning Commission Minutes

  □ Approval of Board Of Board
  - April 11, 2023
- **Zoning Appeals** 
  - PC2321: Naser Jaber; Global Investment Traders, LLC requests a variance of Sec. 90-72 for proposed development of a four-unit quadplex at 4021 6<sup>th</sup> Street; PIN 60019 10016.
- **□** Adjournment
- **□** Planning Commission
  - PC2304: Joshua Yellin; Hunter Maclean requests a general development plan review for proposed development as a service station for electric fleet vehicles to be located at 2202 US Highway 80; PIN 60080 01012, 2207 US Highway 80; PIN 60880 01013, 2301 US Highway 80; PIN 60881 04001, 2303 US Highway 80; PIN 60881 04002, 2305 US Highway 80; PIN 60081 04003 and US Highway 80; PIN 60881 04004
  - O PC2319: Steve Carbone; Industrial Electro Mechanics requests a general development review for construction of a mechanical shop with associated parking and utilities of property formerly known as 1622 Dean Forest Road; PIN 60988A 02007 and now known as 1630 Dean Forest Road PIN 60988A 02034 Lot 7 A, a recombination of a portion of Lot 6 and a portion of Lot 7, on plat entitled "A Recombination Plat of the Northwest Portion of Tract 3" dated October 12, 2022, recorded October 26, 2022 in Plat Book 53, page 545, Chatham County, Georgia records. \*ADDEMDUM (Address Authorization of Plat Recombination has been assigned as 1622 Dean Forest Road)
  - PC2320: Tom Havens; Coastal Civil Engineering requests a general development plan review of for addition of a 5,661 sq. ft. metal building and associated access improvements to1620 Dean Forest Road: PIN 60988A 02009.

#### **□** Adjournment

## PROCEDURES FOR CONDUCTING PUBLIC HEARINGS ON PROPOSED ZONING DECISIONS BEFORE GARDEN CITY'S CONSOLIDATED BOARD OF ZONING APPEALS/PLANNING COMMISSION AND STANDARDS GOVERNING THE EXERCISE OF THE ZONING POWERS OF THE BOARD OF ZONING APPEALS AND THE PLANNING COMMISSION

#### I. Procedures for Conducting Public Hearings on Proposed Zoning Decisions:

All public hearings conducted by the Consolidated Board of Zoning Appeals/Planning Commission for Garden City, Georgia, on proposed zoning decisions shall be conducted as follows:

- All public hearings conducted by the Consolidated Board of Zoning Appeals/Planning Commission on matters referred to it shall be called to order by the presiding officer.
- (2) The presiding officer shall open the hearing by stating the specific zoning matter being considered at the public hearing, and shall explain the procedures to be followed in the conduct of the hearing and further stating that printed copies of the adopted standards governing the exercise of the zoning powers of the Board of Zoning Appeals and Planning Commission, and the procedures governing hearings before the Board are available to the public.
- (3) The presiding officer shall determine the number of attendees who desire to testify or present evidence at the hearing.
- (4) When there is a large number of individuals wishing to testify at a hearing, the presiding officer may invoke time limits on individual speakers. In such cases, these time limits shall apply to all speakers. Proponents, including the petitioner or the petitioner's agent requesting the zoning decision, shall have no less than ten (10) minutes for the presentation of data, evidence, and expert opinions; opponents of the proposed decision shall have an equal minimum period of time. The presiding officer may grant additional time; provided, however, an equal period of time shall be granted both sides.
- (5) The petitioner requesting the proposed decision, or the petitioner's agent, shall be recognized first and shall be permitted to present and explain the request for the decision. Thereafter, all individuals who so desire shall be permitted to speak in favor of the matter.
- (6) After all individuals have had an opportunity to speak in accordance with subparagraph (5) above, those individuals present at the public hearing who wish to speak in opposition to the proposed decision shall have an opportunity to speak.
- (7) Once all parties have concluded their testimony, the presiding officer shall adjourn the public hearing.

#### II. Standards Governing the Exercise of The Zoning Powers of Garden City's Board of Zoning Appeals: The Board of Zoning Appeals shall have the following powers:

- (1) To hear and decide appeals where it is alleging that there is an error in any order, requirement, decision, or determination made by an administrative official in the enforcement of Chapter 90 of the Garden City Code of Ordinances.
- (2) To decide upon requests for permission to establish uses which the Board of Zoning Appeals is required to pass under the terms of Chapter 90 of the Garden City Code of Ordinances. The application to establish such use shall be approved on a finding of the Board of Zoning Appeals that:
  - (a) The proposed use does not affect adversely the general plans for the physical development of the city, as embodied in Chapter 90 of the Garden City Code of Ordinances and in any master plan or portion thereof adopted by the Mayor and Council.
  - (b) The proposed use will not be contrary to the purposes stated for Chapter 90 of the Garden City Code of Ordinances.
  - (c) The proposed use will not affect adversely the health and safety of residents and workers in the city.
  - (d) The proposed use will not be detrimental to the use or development of adjacent properties or the general neighborhood.
  - (e) The proposed use will not adversely affect the existing uses in the neighborhood.
  - (f) The proposed use will be placed on a lot of sufficient size to satisfy the space requirements of such use.
  - (g) The proposed use will not constitute a nuisance or hazard because of the number of persons who will attend or use such facility, vehicular movement, noise or fume generation or type of physical activity.

(h) The standards set forth for each particular use for which a permit may be granted have been met.

The Board of Zoning Appeals may impose or require such additional restrictions and standards as may be necessary to protect the health and safety of workers and residents in the community and to protect the value and use of the property in the general neighborhood. The proposed use shall be subject to the minimum area, setback, and other locational requirements of the zoning district in which it will be located. The proposed use shall be subject to the off-street parking and service requirements of Chapter 90 of the Garden City Code of Ordinances. Wherever the Board of Zoning Appeals shall find, in the case of any permit granted pursuant to the provisions of said Chapter 90, that any of the terms, conditions or restrictions upon which such permit was granted are not being complied with, the Board shall rescind and revoke such permit after giving due notice to all parties concerned and granting full opportunity for a public hearing.

- (3) To authorize upon appeal in specific cases such variance from the terms of Chapter 90 of the Garden City Code of Ordinances as will not be contrary to the public interest where owing to special conditions a literal enforcement of the provisions of said Chapter will, in an individual case, result in practical difficulty or unnecessary hardship. Such variance may be granted in such individual cases of practical difficulty or unnecessary hardship upon a finding by the Board of Appeals that:
  - (a) There are extraordinary and exceptional conditions pertaining to the particular piece of property in question because of its size, shape, or topography;
  - (b) The application of said Chapter 90 to this particular piece of property would create practical difficulty or unnecessary hardship;
  - (c) Such conditions are peculiar to the particular piece of property involved; and,
  - (d) Relief, if granted, would not cause substantial detriment to the public good or impair the purpose and intent of said Chapter 90.

No variance shall be granted for a use of land or building or structure that is prohibited by Chapter 90 of the Garden City Code of Ordinances.

#### III. Powers and Duties of the Planning Commission.

The Planning Commission is granted all powers and is assigned all duties that the City's Mayor and Council is authorized and empowered to grant and assign, to include the following:

- (1) Making comprehensive surveys and studies of existing conditions and probable future developments and preparing such plans for physical, social, and economic growth as will best promote the public health, safety, morals, convenience, prosperity, or general welfare, as well as efficiency and economy in the development of the city.
- (2) Preparing a master plan or parts thereof for the development of the city.
- (3) Preparing and recommending for adoption to the city council a zoning ordinance or resolution and map for the city.
- (4) Preparing and recommending for adoption to the city council regulations for the subdivision of land within the city, and administering the regulations that may be adopted.
- (5) Preparing and recommending for adoption to the city council a plat or an official map showing the exact location of the boundary lines of existing, proposed, extended, widened, or narrowed streets, public open spaces, or public building sites, together with regulations to control the erection of buildings or other structures within such lines, within the city or a specified portion thereof.
- (6) Making, publishing, and distributing maps, plans, and reports and recommendations relating to the master plan and development of the city to public officials and agencies, public utility companies and civic, educational, professional, and other organizations and citizens.
- (7) Recommending to the executive or legislative officials of the city programs for public improvements and the financing thereof.
- (8) Reviewing all proposed amendments to the zoning ordinance, the subdivision ordinance, and the zoning map, and making recommendation as per Garden City Code Section 90-201 in each case to the city council for approval or denial.
- (9) Approving site and development plans as per Garden City Code Sections 90-43, 90-47, 90-48 and 90-49.
- (10) Approving certain uses in the mixed-use zoning districts as per Garden City Code Section 90-49.

### PROCEDURES FOR CONDUCTING PUBLIC HEARINGS ON PROPOSED ZONING DECISIONS BEFORE GARDEN CITY'S MAYOR AND COUNCIL AND STANDARDS GOVERNING THE EXERCISE OF CITY COUNCIL'S ZONING POWER

#### Procedures for Conducting Public Hearings on Proposed Zoning Decisions:

All public hearings conducted by the Board of Zoning Appeals for Garden City, Georgia, on proposed zoning decisions shall be conducted as follows:

- (1) All public hearings by the Mayor and Council on zoning amendments shall be chaired by the Mayor.
- (2) The Mayor shall open the hearing by stating the specific zoning amendment being considered at the public hearing and further stating that printed copies of the adopted standards governing the exercise of the Mayor and Council's zoning power and the procedures governing the hearing are available to the public.
- (3) The Director of the City's Planning and Zoning Department shall advise the Mayor and Council of the recommendation of the Planning Commission when applicable.
- (4) The Mayor shall determine the number of attendees who desire to testify or present evidence at the hearing.
- (5) When there is a large number of individuals wishing to testify at a hearing, the Mayor may invoke time limits on individual speakers. In such cases, these time limits shall apply to all speakers. Proponents, including the petitioner or the petitioner's agent requesting the zoning decision, shall have no less than ten (10) minutes for the presentation of data, evidence, and expert opinions; opponents of the proposed decision shall have an equal minimum period of time. The Mayor may grant additional time; provided, however, an equal period of time shall be granted both sides.
- (6) The petitioner requesting such zoning decision, or the applicant's agent, shall be recognized first and shall be permitted to present and explain the request for the zoning decision. Thereafter, all individuals who so desire shall be permitted to speak in favor of the zoning decision.
- (7) After all individuals have had an opportunity to speak in accordance with subparagraph (6) above, those individuals present at the public hearing who wish to speak in opposition to the requested zoning decision shall have an opportunity to speak.
- (8) The Mayor may limit repetitious comments in the interest of time and may call for a show of hands of those persons present in favor of or opposed to the proposed decision.
- (9) It shall be the duty of the Mayor to maintain decorum and to assure the public hearing on the proposed decision is conducted in a fair and orderly manner.
- (10) Once all parties have concluded their testimony, the Mayor shall adjourn the public hearing.

#### Standards Governing the Exercise of The Zoning Powers of Garden City's Mayor and Council:

Prior to making a zoning amendment, the Mayor and Council shall evaluate the merits of a proposed amendment according to the following criteria:

- (1) Is this request a logical extension of a zoning boundary which would improve the pattern of uses in the general area?
- (2) Is this spot zoning and generally unrelated to either existing zoning or the pattern of development of the area?
- (3) Could traffic created by the proposed use or other uses permissible under the zoning sought traverse established single-family neighborhoods on minor streets, leading to congestion, noise, and traffic hazards?
- (4) Will this request place irreversible limitations or cause material detriment on the area similarly zoned as it is or on future plans for it?
- (5) Is there an imminent need for the rezoning and is the property likely to be used for the use requested?
- (6) Would the proposed use precipitate similar requests which would generate or accelerate adverse land use changes in the zone or neighborhood?

#### Board of Zoning Appeals/Planning Commission April 11, 2023 - 6:00PM

Opening: Chair Billy Jackson welcomed everyone and called the meeting to order.

Roll Call: Billy Jackson; Chair, Jenecia Perry; Vice-Chair, Jeff Ashley; Parliamentarian, Michael Bruner, Misty Selph, Gary Monroe, and Charles Orrel.

Staff: Denise Grabowski (Planning Manager -Consultant-), Jonathan Trego (Planning and Zoning Supervisor), and Tonya Roper (Permitting and Inspections Coordinator).

Visitors: Enclosed

Chair Jackson calls for a motion to approve the agenda. Commissioner Perry made a motion, Commissioner Selph seconded, vote passes with no opposition.

Commissioner Orrel made a motion to approve the minutes. Commissioner Cox seconded, vote passes with no opposition.

#### **Board of Zoning Appeals**

PC2318: Michael Shropshire, property owner requests a variance of Sec.90-14 to build 2376 sq. ft. garage/carport at 216 Salt Creek Road; PIN 60960 01016.

Chair Jackson gave a reading of the item. Planning Consultant Denise Grabowski gave an overview of the proposal. They City had no recommendation.

Applicant Michael Shropshire came forward and gave a quick summary of his plans.

Vice-Chair Perry asked about the use of the structure.

The applicant said it would be used for parking of cars, toys, and storage.

Commissioner Monroe confirmed the property lines with the applicant.

Denise Grabowski clarified the setback requirements.

Commissioner Monroe asked if there would be plumbing.

The applicant said no, not at this time.

Chair Jackson calls for a motion. Commissioner Selph makes a motion to approve, Commissioner Cox seconded. Vote passes without opposition.

Vice-chair Perry made a motion to adjourn the ZBA meeting, Commissioner Cox seconded, vote passes with no opposition.

Minutes Board of Zoning Appeals/Planning Commission April 11, 2023 – 6:00pm

#### **Planning Commission**

Chair Jackson called the Planning Commission meeting to order for nominations/elections.

For the position of Chair, Billy Jackson was nominated by Commissioner Cox. Gary Monroe was nominated by Commissioner Perry. Billy Jackson received 6 votes and Gary Monroe received 2 votes. Billy Jackson was elected Chair.

For the position of Vice-Chair, Commissioner Jackson nominates Jenecia Perry. Commissioner Selph nominates Michael Bruner. Jenecia Perry received 5 votes, Michael Bruner received 3 votes. Jenecia Perry was elected Vice-Char.

For the position of Parliamentarian, Vice-Chair Perry nominates Jeff Ashley. Commissioner Ashley nominates Michael Bruner. Jess Ashley receives 3 votes. Michael Bruner receives 5 votes. Michael Bruner was elected Parliamentarian.

Commissioner Selph made a motion to adjourn, Commissioner Cox seconded. Motion passes with no opposition.

Respectfully submitted JRT

#### **City of Garden City Variance Application**



#### **Development Information**

Development Name (If applicable)	
Property Address	
Current Zoning	Current Use
Parcel ID	Total Site Acreage
Section of the zoning code from which you are seeking a variance:	
Describe the variance request you are requesting.	
Would denial of this request create practical difficulty or an unnec	essary hardship?
Does the property have extraordinary and exceptional conditions	because of its size, shape or topography?
Are the conditions of the property unique to this piece of property	<i>i</i> ?
Would approval of this variance request cause any detriment to a	djoining properties or the community?
Please provide any additional information that you deem relevant	

#### **City of Garden City Variance Application**



#### **Applicant Information**

Owner		
Name	Address	
Phone	Email	
Nature of Ownership Interest		
·	□ Sole Proprietor □ Firm □ Corporation	□ Association
Note: If a corporation, submit a list of officers, dir		
If a partnership: Submit list of all partners with na		and title.
		eive staff review comments via email
Company Name	Contact (Individual Name)	
,		
Phone	Email	
Authorized Agent (Requires Authorized Agent Fo	orm)   Check here to rece	eive staff review comments via email
Company Name	Contact (Individual Name)	
	-	
Phone	Email	
 Campaign Contribution		
List below the names of local government officials	Garden City City Council to whom campaign	contributions were made, within two (2)
years immediately preceding the filing of this app		
made having a total value of \$250.00 or more.	meation, which campaign contributions total \$2	250.00 of more of to whom girts were
Elected Official's Name	Amount or Description of	Gift
•		
l understand that I will need to attend or be r	enresented by a duly authorized agent at	the meeting of the Board of Zoning
Appeals and that my application cannot be a		the meeting of the board of zoning
Appeals and that my application calliot be ap	oproved unless rain represented.	
	Nana Oakas	
Print Name	<u>Naser Jaber</u> Signature	Date
rinic ivanie	Signature //	Date

OFFICE USE ONLY				
Received By			Date Received	Case Number
Submittal Format	- Danes			Invoice Number
□ Electronic	□ Paper	□ Both		



#### **MEMORANDUM**

**To:** Garden City Planning Commission & Board of Appeals

From: Denise R. Grabowski, AICP, LEED AP, Planning Consultant

**Date:** May 4, 2022

Re: PC 2312 – 2782 US Highway 80 West, Garden City

Application Type	Variance
Case Number	PC 2312
Applicant	Naser Jab <mark>er</mark>
Name of Project	4021 6th Street
Property Address	4021 6 <sup>th</sup> Street
Parcel ID	60019 10016
Area of Property	.28 acres
Existing Zoning	Residential, R-2
Existing Land Use	Un <mark>developed</mark>
Proposed Land Use	Residential Quadplex

#### **GENERAL INFORMATION**

*Project Description*: The applicant is requesting a variance from Section 90-72, Dwellings (development standards) to construct a quadplex on the property. The lot is 80 feet wide. The minimum lot width for a multi-family building in R-2 is 120 feet. Therefore, the applicant is requesting a variance from the lot width requirements.

Background / Additional Context: Staff met with the applicant after receiving the initial application, which was for three units. The design of the units as initially proposed was not in keeping with the character of the existing neighborhood. The applicant revised the proposal and incorporated staff feedback regarding the architectural design of the proposed structure.

#### **FINDINGS**

Staff has determined this application is complete and contains all required information. In conformance with the City of Garden City Zoning Ordinance Section 90-213(3), the Board of Appeals may authorize upon appeal in specific cases such variance from the terms of the zoning ordinance as will not be contrary to the public interest where owing to special conditions a literal enforcement of the provisions of this chapter will, in an individual case, result in practical difficulty



or unnecessary hardship. Such variance may be granted in such individual cases of practical difficulty or unnecessary hardship upon a finding by the board of appeals that:

- There are extraordinary and exceptional conditions pertaining to the particular piece of property in question because of its size, shape or topography;
   The property in question does not have any extraordinary conditions due to its size, shape, or topography.
- The application of this chapter to this particular piece of property would create practical difficulty or unnecessary hardship;
   This lot could be developed with a single-family dwelling.
- 3. Conditions are peculiar to the particular piece of property involved; and This neighborhood was historically developed with 40-foot-wide lots so development of a two-family structure on an 80-foot-wide lot would be in keeping with the overall density of the neighborhood. Staff would support the proposed structure and variance request if the structure were modified from a quadplex to a two-family dwelling. A two-family dwelling would also require a variance request, as a 100-foot lot width is required.
- 4. Relief, if granted, would not cause substantial detriment to the public good or impair the purpose and intent of this chapter.
  Relieve, if granted, would allow for construction of a structure that is not in keeping with the character of the area.

#### RECOMMENDATION

**Denial** of the variance request.

#### Note:

Approval, if granted, by the Planning Commission only constitutes the initial step in the overall process and additional requirements still must be met prior to commencement of any construction activities. The Petitioner should note that final approval of the site plan will require City staff approval of the detailed engineering plans for the project through the City's standard process and a Land Disturbance Activity (LDA) Permit must be issued prior to construction. The Petitioner should also note that final approval of the site architectural plans will require City staff approval via its standard process and a building permit must be issued before vertical construction shall commence.



Flats on 6th (Quadraplex) 4021 Sixth Street Garden City, Georgia

4/14/23

CONCEPT

#### PC2321: Variance



Owner, PIN and Address Labels

GARDEN CITY SAVANNAH

■ VERNONBURG

SAGIS

#### **City of Garden Site Plan Application**



#### **Development Information**

Development Name				
Voltera - EV Fleet Charging Hub				
Property Address				
2205, 2207, 2301, 2303, and 2305 W	est US Highway 80	)		
	oot oo i ngiimay oo			
Phonod dovolonoment?		If was indicate arou		••••
Phased development?		if yes, indicate prop	osed number of phas	ses:
□ Yes ■ No				
Parcel ID	Total Site Acreage		Zoning	
60880-01012 & 01013 60881-04001 to 04004	7.91		C-2	
Project Description				
Service station for electric fleet vehicl	es			
Water Supply		Sewage Disposal		
■ Public □ Private		□ Public ■ Priva	te	
Applicant Information				
Owner		Address		
Name		Address		
B.G. Bazemore Holding	gs, LLC	•	rs Circle, Suite 20	7, Pooler, GA 31322
Phone		Email		
Ī	me as authorized agen			v comments via email
Company Name		Contact (Individual N	lame)	
Kimley-Horn			Mike Lopez	
Phone		Email		
912-328-4442		mike	e.lopez@kimley-h	orn.com
Authorized Agent (Requires Authorized Age	nt Form)			v comments via email
Company Name		Contact (Individual N	lame)	
HunterMaclean			Josh Yellin	
Phone		Email		
912-236-0261		jyelliı	n@huntermack	ean.com
•		•		
understand that I will need to attend or				of the Planning
Commission and that my application can	not be approved unle	ess I am represented	l.	
Joshua Yellin		n 20		12/09/2022
Print Name	Signature			Date
	OFFICE	HEE ONLY		

OFFICE USE ONLY				
Received By			Date Received	Case Number
Submittal Format			Fee Amount Paid	Invoice Number
□ Electronic	□ Paper	□ Both		



#### **MEMORANDUM**

**To:** Garden City Planning Commission & Board of Appeals

From: Denise R. Grabowski, AICP, LEED AP, Planning Manager Consultant

**Date:** May 2, 2023

**Re:** PC 2304 – 2202-2205 US Highway 80

Application Type	General Development Plan
Case Number	PC 2304
Applicant	Joshua Ye <mark>llin</mark>
Name of Project	Voltera EV Fleet Charging Hub
Property Address	2202-2305 US Highway 80
Parcel IDs	60080 01012, 60880 01013, 60881 04001, 60881 04002, 60081 04003, PIN 60881 04004
Area of Property	7.91 acres
Current Zoning	C-2, Commercial
Proposed Land Use	Service station for electric fleet vehicles

#### **GENERAL INFORMATION**

*Project Description*: The applicant is proposing to develop a state-of-the-art electric vehicle (EV) charging facility with 127 truck charging stalls and 127 vehicle parking stalls, 4,800 square-foot operations building, and 4,500 square-foot maintenance building.

#### **FINDINGS**

Staff has determined this application is complete and contains all required information. In conformance with the City of Garden City Zoning Ordinance Section 90-48, the following factors are to be considered for a General Development Plan review:

1. Proposed uses and overall development plan This facility is the first of its kind in the area and will provide charging facilities for electric vehicles and trucks. The project is proposed for development in two phases. The first phase will include both buildings, passenger vehicle parking, and 37 truck charging stations. The second phase will add an additional 90 truck charging stations. Phase I is anticipated by the end of 2024; the timing for Phase II is to be determined.



- 2. Façade elevation plan indicating building orientation and scale; exterior construction materials, including texture and color; roof shape, window and door openings, porches, and balconies; architectural style or structure and the facade architectural treatment. The operations building will be located adjacent to US Highway 80 and features metal and spandrel panels with storefront glazing (windows). A smaller maintenance facility is located adjacent to the western property line and will be constructed of masonry.
- 3. Fences, landscaping, and buffers.

  The perimeter of the site will be surrounded by 8' wrought iron fencing. A black chainlink fence will be located around the truck charging stations. The required landscape buffer along US Highway 80, as well as tree islands in the parking lot, will be provided. A 25' landscape buffer is also required along the southern property line. The plans include a note that states the site, buffer, and parking lot landscaping will be designed in compliance with the City of Garden City Zoning Ordinance.
- 4. Driveway and parking orientation, in keeping with the established character in the area. Site access is provided via US Highway 80, with the addition of a right-hand deceleration lane on US Highway 80. The site is designed to separate passenger vehicles from trucks immediately after entering the site.
- 5. Scale, design, and location of exterior signs. Special sign restrictions may be required based on the location and character of the development and surrounding area.

  A monument sign will be provided adjacent to US Highway 80. Signage shall comply with the City of Garden City ordinances and will require a sign permit.

The applicant has provided the required information.

#### RECOMMENDATION

**Approval** of the General Development Plan.

#### Note:

Approval, if granted, by the Planning Commission only constitutes the initial step in the overall process and additional requirements still must be met prior to commencement of any construction activities. The Petitioner should note that final approval of the site plan will require City staff approval of the detailed engineering plans for the project through the City's standard process and a Land Disturbance Activity (LDA) Permit must be issued prior to construction. The Petitioner should also note that final approval of the site architectural plans will require City staff approval via its standard process and a building permit must be issued before vertical construction shall commence.

### SITE PLAN APPLICATION PLANS

FOR



# VOLTERA EV FLEET CHARGING FACILITY

2303 US HIGHWAY 80 GARDEN CITY, GA 31408 CITY OF GARDEN CITY

CONSOLIDATED PARCELS: 6-0880-01-012, 6-0880-01-013, 6-0881-04-001, 6-0881-04-002, 6-0881-04-003, 6-0881-04-004

**APPLICANT:** 

VOLTERA POWER, LLC CONTACT: PETER THOMAS PHONE: (513) 221-9761

EMAIL: PTHOMAS@VOLTERAPOWER.COM

#### **PROPERTY OWNER:** SAVANNAH EV HOLDINGS, LLC

CONTACT: PETER THOMAS PHONE: (513) 221-9761 PTHOMAS@VOLTERAPOWER.COM

#### **PROGRAM MANAGER:** KIMLEY-HORN & ASSOCIATES, INC.

**PROJECT TEAM** 

**LOCATION MAP** 

CONTACT: DEAN APOSTOLERIS PHONE: (914) 368-9199 EMAIL: DEAN.APOSTOLERIS@KIMLEY-HORN.COM

#### **ARCHITECT:**

CONTACT: EMILY O'LOUGHLIN (703) 564-8484 EMILY.OLOUGHLIN@MG2.COM

#### CIVIL ENGINEER: KIMLEY-HORN & ASSOCIATES, INC.

CONTACT: BRIAN CLOUSER, P.E. BRIAN.CLOUSER@KIMLEY-HORN.COM

#### **ELECTRICAL ENGINEER:** KIMLEY-HORN & ASSOCIATES, INC.

CONTACT: JEFFREY SALLEE, P.E. PHONE: (757) 213-8635

#### **MECHANICAL ENGINEER:** KIMLEY-HORN & ASSOCIATES, INC.

CONTACT: MICHAEL STREICH

(331) 888-3178 MIKE.STREICH@KIMLEY-HORN.COM

#### **SURVEYOR:**

JAMES M. ANDERSON & ASSOCIATES, INC. CONTACT: MATT ANDERSON, PLS

PHONE: (912) 764-2002 MATT@ANDERSONLANDSURVEYORS.CO

#### **GEOTECHNICAL ENGINEER:** TERRACON CONSULTANTS, INC.

CONTACT: GUOMING LIN, P.E. PHONE: (912) 200-9114 GUOMING.LIN@TERRACON.COM

#### **ENVIRONMENTAL:**

TERRACON CONSULTANTS, INC. CONTACT: KERRI DOYLE PHONE: (912) 200-9109 EMAIL: KERRI.DOYLE@TERRACON.COM

ALL WORK AND MATERIALS SHALL BE PERFORMED AND INSTALLED IN ACCORDANCE WITH THE CURRENT EDITIONS OF THE BUILDING/ DWELLING, STRUCTURAL, PLUMBING, MECHANICAL,

ELECTRICAL, AND FIRE/LIFE SAFETY CODES AS ADOPTED BY THE LOCAL GOVERNING AUTHORITIES NOTHING IN THESE PLANS IS TO BE CONSTRUCTED TO PERMIT WORK NOT CONFORMING TO THE LOCAL GOVERNING AUTHORITIES CODES.

**CODE BLOCK** 

**VICINITY MAP** 


THE APPLICANT IS PROPOSING TO DEVELOP A STATE-OF-THE ART, ELECTRIC VEHICLE (EV) CHARGING
FACILITY FOR FREIGHT VEHICLE FLEET OPERATION AND CHARGING. A TOTAL OF 127 CHARGING STALLS
ARE PROVIDED FOR CLASS 8 TRUCKS WITH A 1:1 RATIO OF PASSENGER VEHICLE PARKING STALLS. A
PROPOSED 4,800 SQUARE-FOOT OPERATIONS BUILDING WILL SERVE THE FACILITY WITH INTERIOR OFFICE
SPACE, IN ADDITION TO A 4,500 SQUARE-FOOT MAINTENANCE BUILDING WITH 3 TRUCK BAYS.

C-0.0	COVER SHEET
C-2.0	EXISTING CONDITIONS
C-3.0	CIVIL LAYOUT PLAN - PHASE 1

**SHEET NUMBER** 

C-3.1

**PROJECT NARRATIVE** 

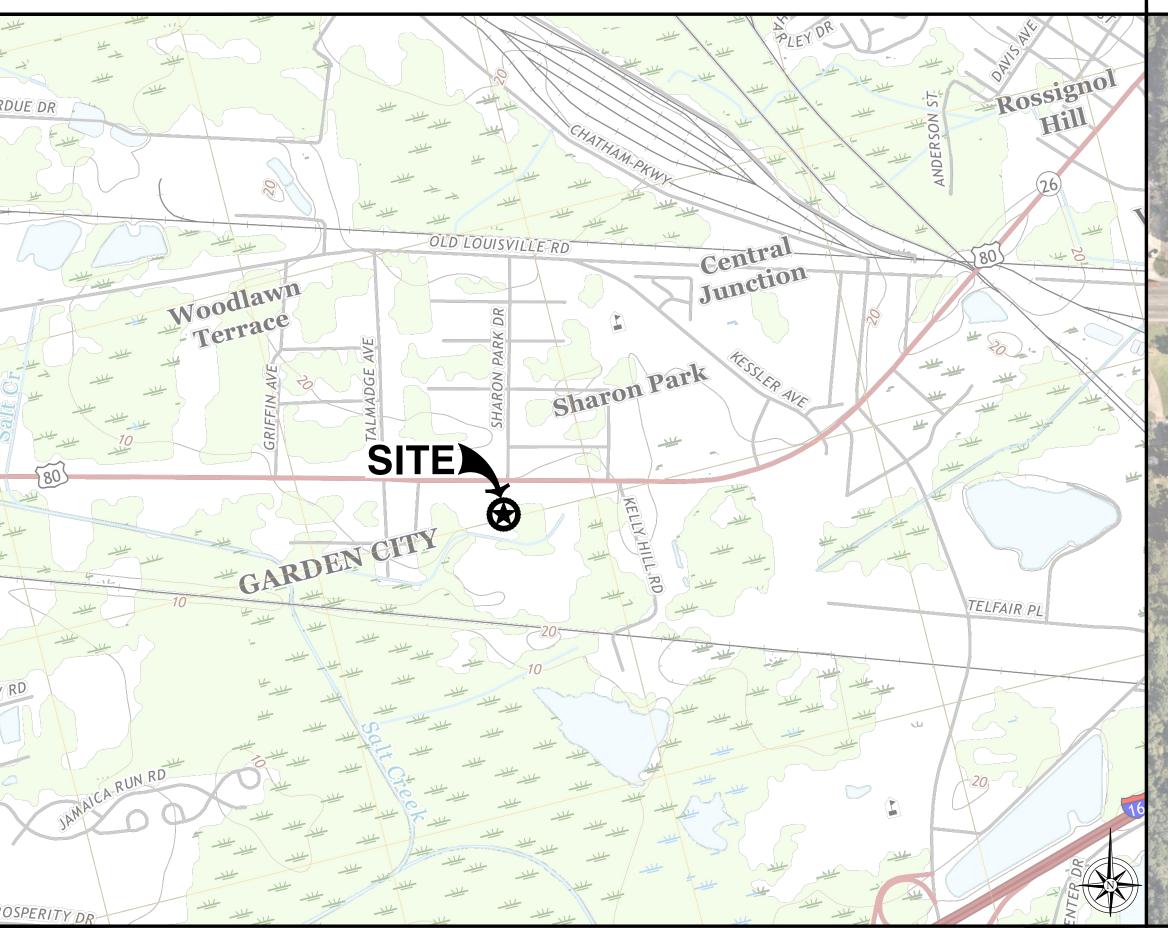



ES-1.0	SITE ELECTRICAL EQUIPMENT LAYOUT - PHASE 1
ES-1.1	SITE ELECTRICAL EQUIPMENT LAYOUT - PHASE 2
A-1.0	PLAN & ELEVATIONS - OPERATIONS BUILDING
A-1.1	PLAN & ELEVATIONS - MAINTENANCE BUILDING
M-1.0	OPERATIONS BUILDING MECHANICAL PLAN - LEVEL 1
M-1.1	OPERATIONS BUILDING MECHANICAL PLAN - ROOF
M-1.2	MAINTENANCE BUILDING MECHANICAL PLAN - LEVEL 1
M-1.3	MAINTENANCE BUILDING MECHANICAL PLAN - ROOF
E-1.0	ELECTRICAL POWER PLAN - OPERATIONS BUILDING
E-1.1	ELECTRICAL POWER PLAN - MAINTENANCE BUILDING
E-2.0	ELECTRICAL ONE-LINE DIAGRAM - PHASE 1
E-2.1	ELECTRICAL ONE-LINE DIAGRAM - PHASE 2
E-2.2	ELECTRICAL ONE-LINE DIAGRAM - PHASE 2

#### **SHEET INDEX**



Know what's BELOW. CALL before you dig.

**SHEET TITLE** 

CIVIL LAYOUT PLAN - PHASE 2

CALL AT LEAST THREE WORKING DAYS BEFORE YOU DIG

CONTRACTOR SHALL VERIFY ALL PLANS & EXISTING LOCATIONS, CONDITIONS ON THE JOB

**CALL BEFORE YOU DIG** 

SHEET NUMBER C-0.0

COVER

SHEE


NOT FOR CONSTRUCTION

8444 Westpark Dr, Ste 120

McLean, VA 22102 703 564 8484

Kimley » Horn

SHEET SET

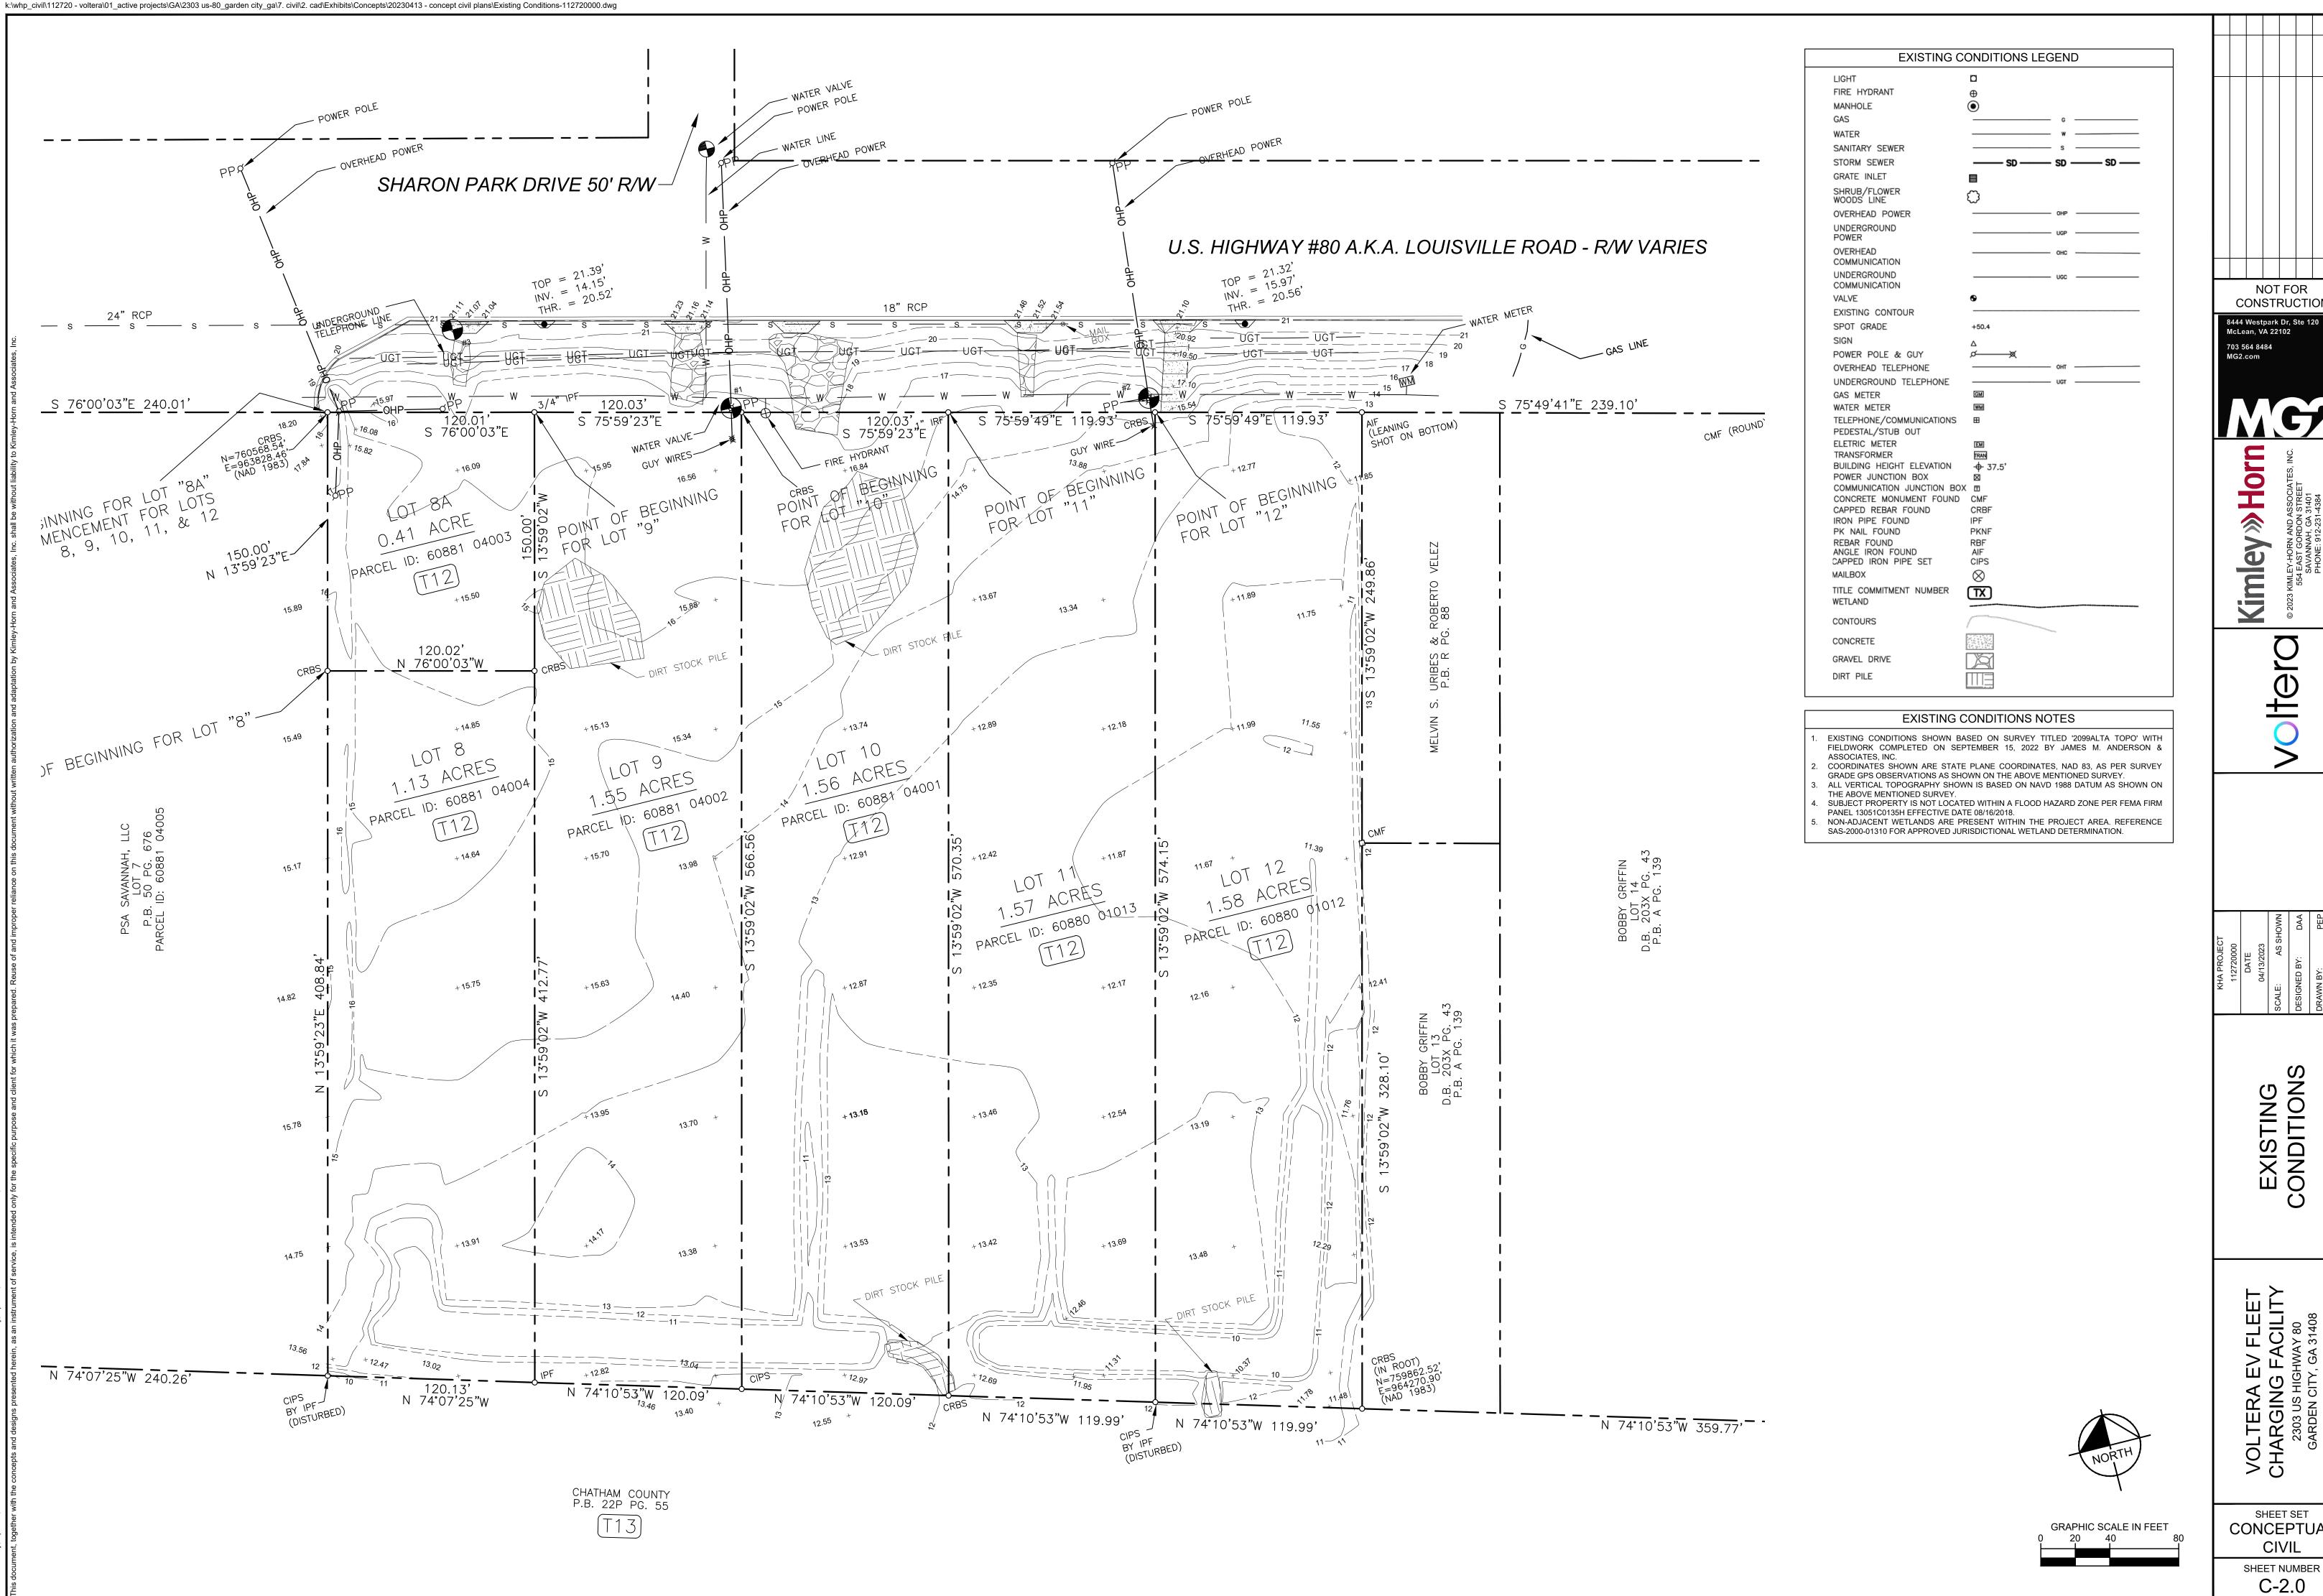


NOT FOR CONSTRUCTION 8444 Westpark Dr, Ste 120 McLean, VA 22102 703 564 8484 MG2.com

EXISTING CONDITIONS

VOLTERA EV F
CHARGING FA(
2303 US HIGHWA)
GARDEN CITY, GA 3

SHEET SET
CONCEPTUAL CIVIL

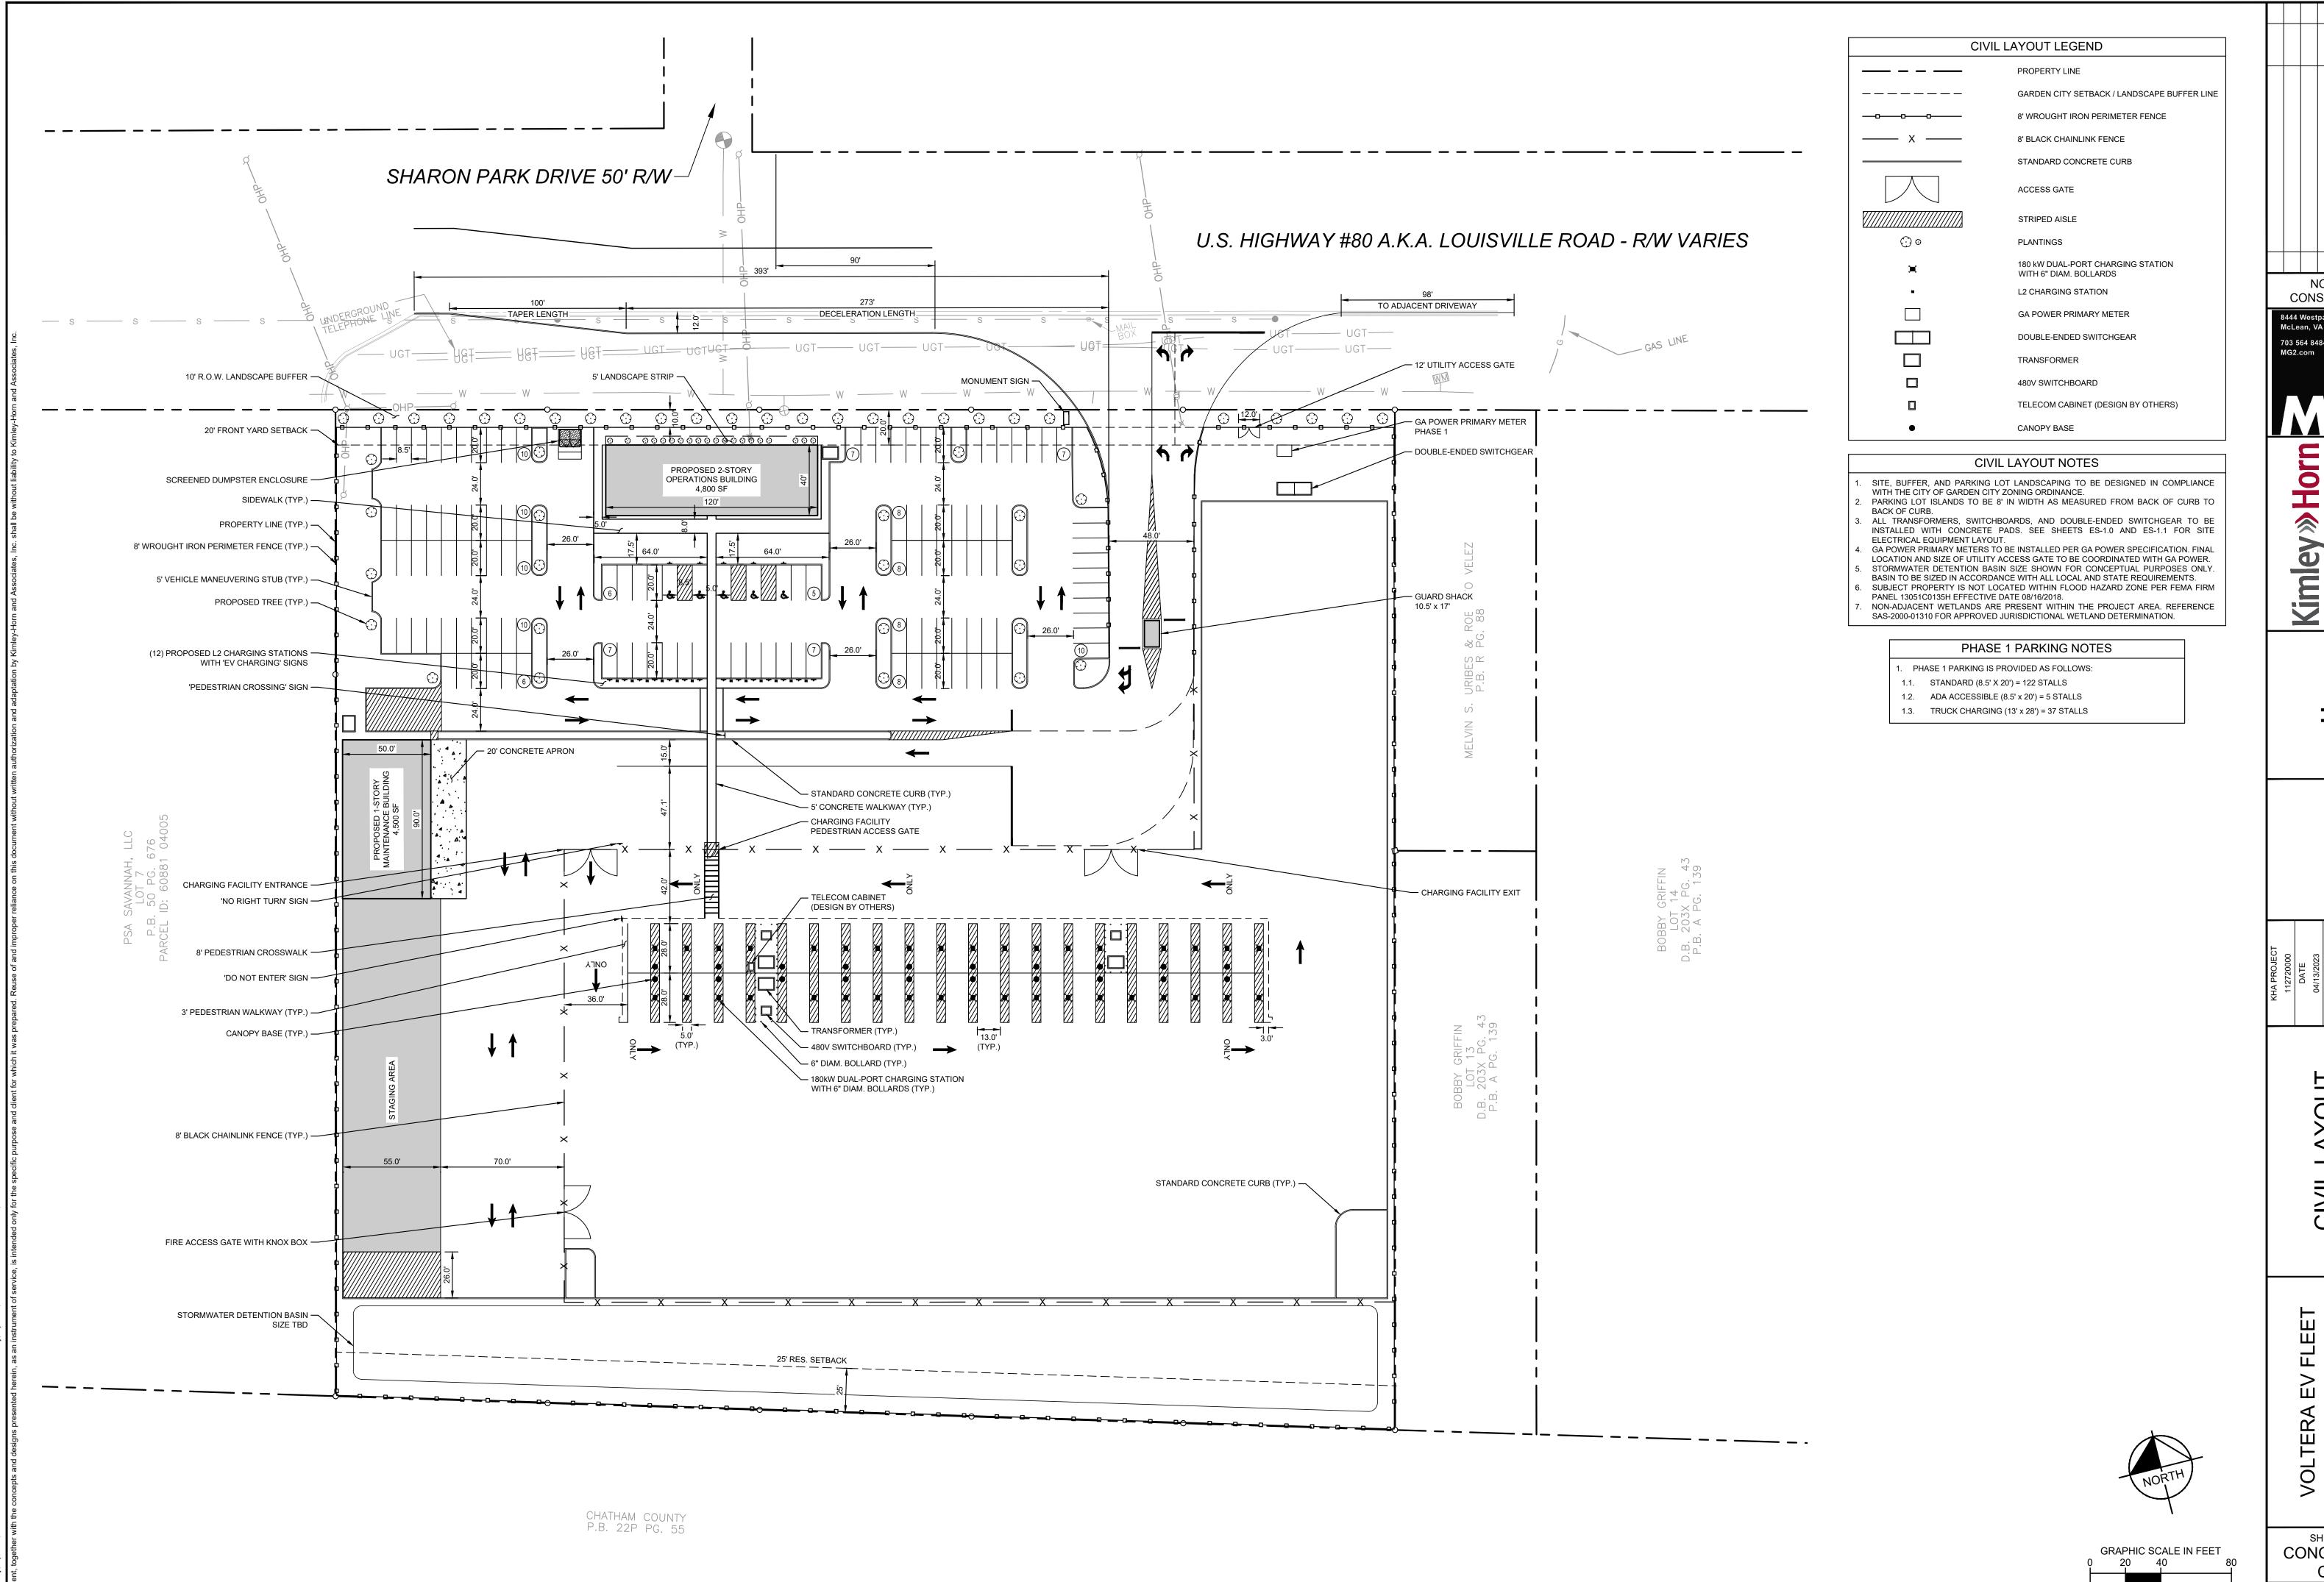


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SHEET SET CONCEPTUAL CIVIL

> SHEET NUMBER C-3.0



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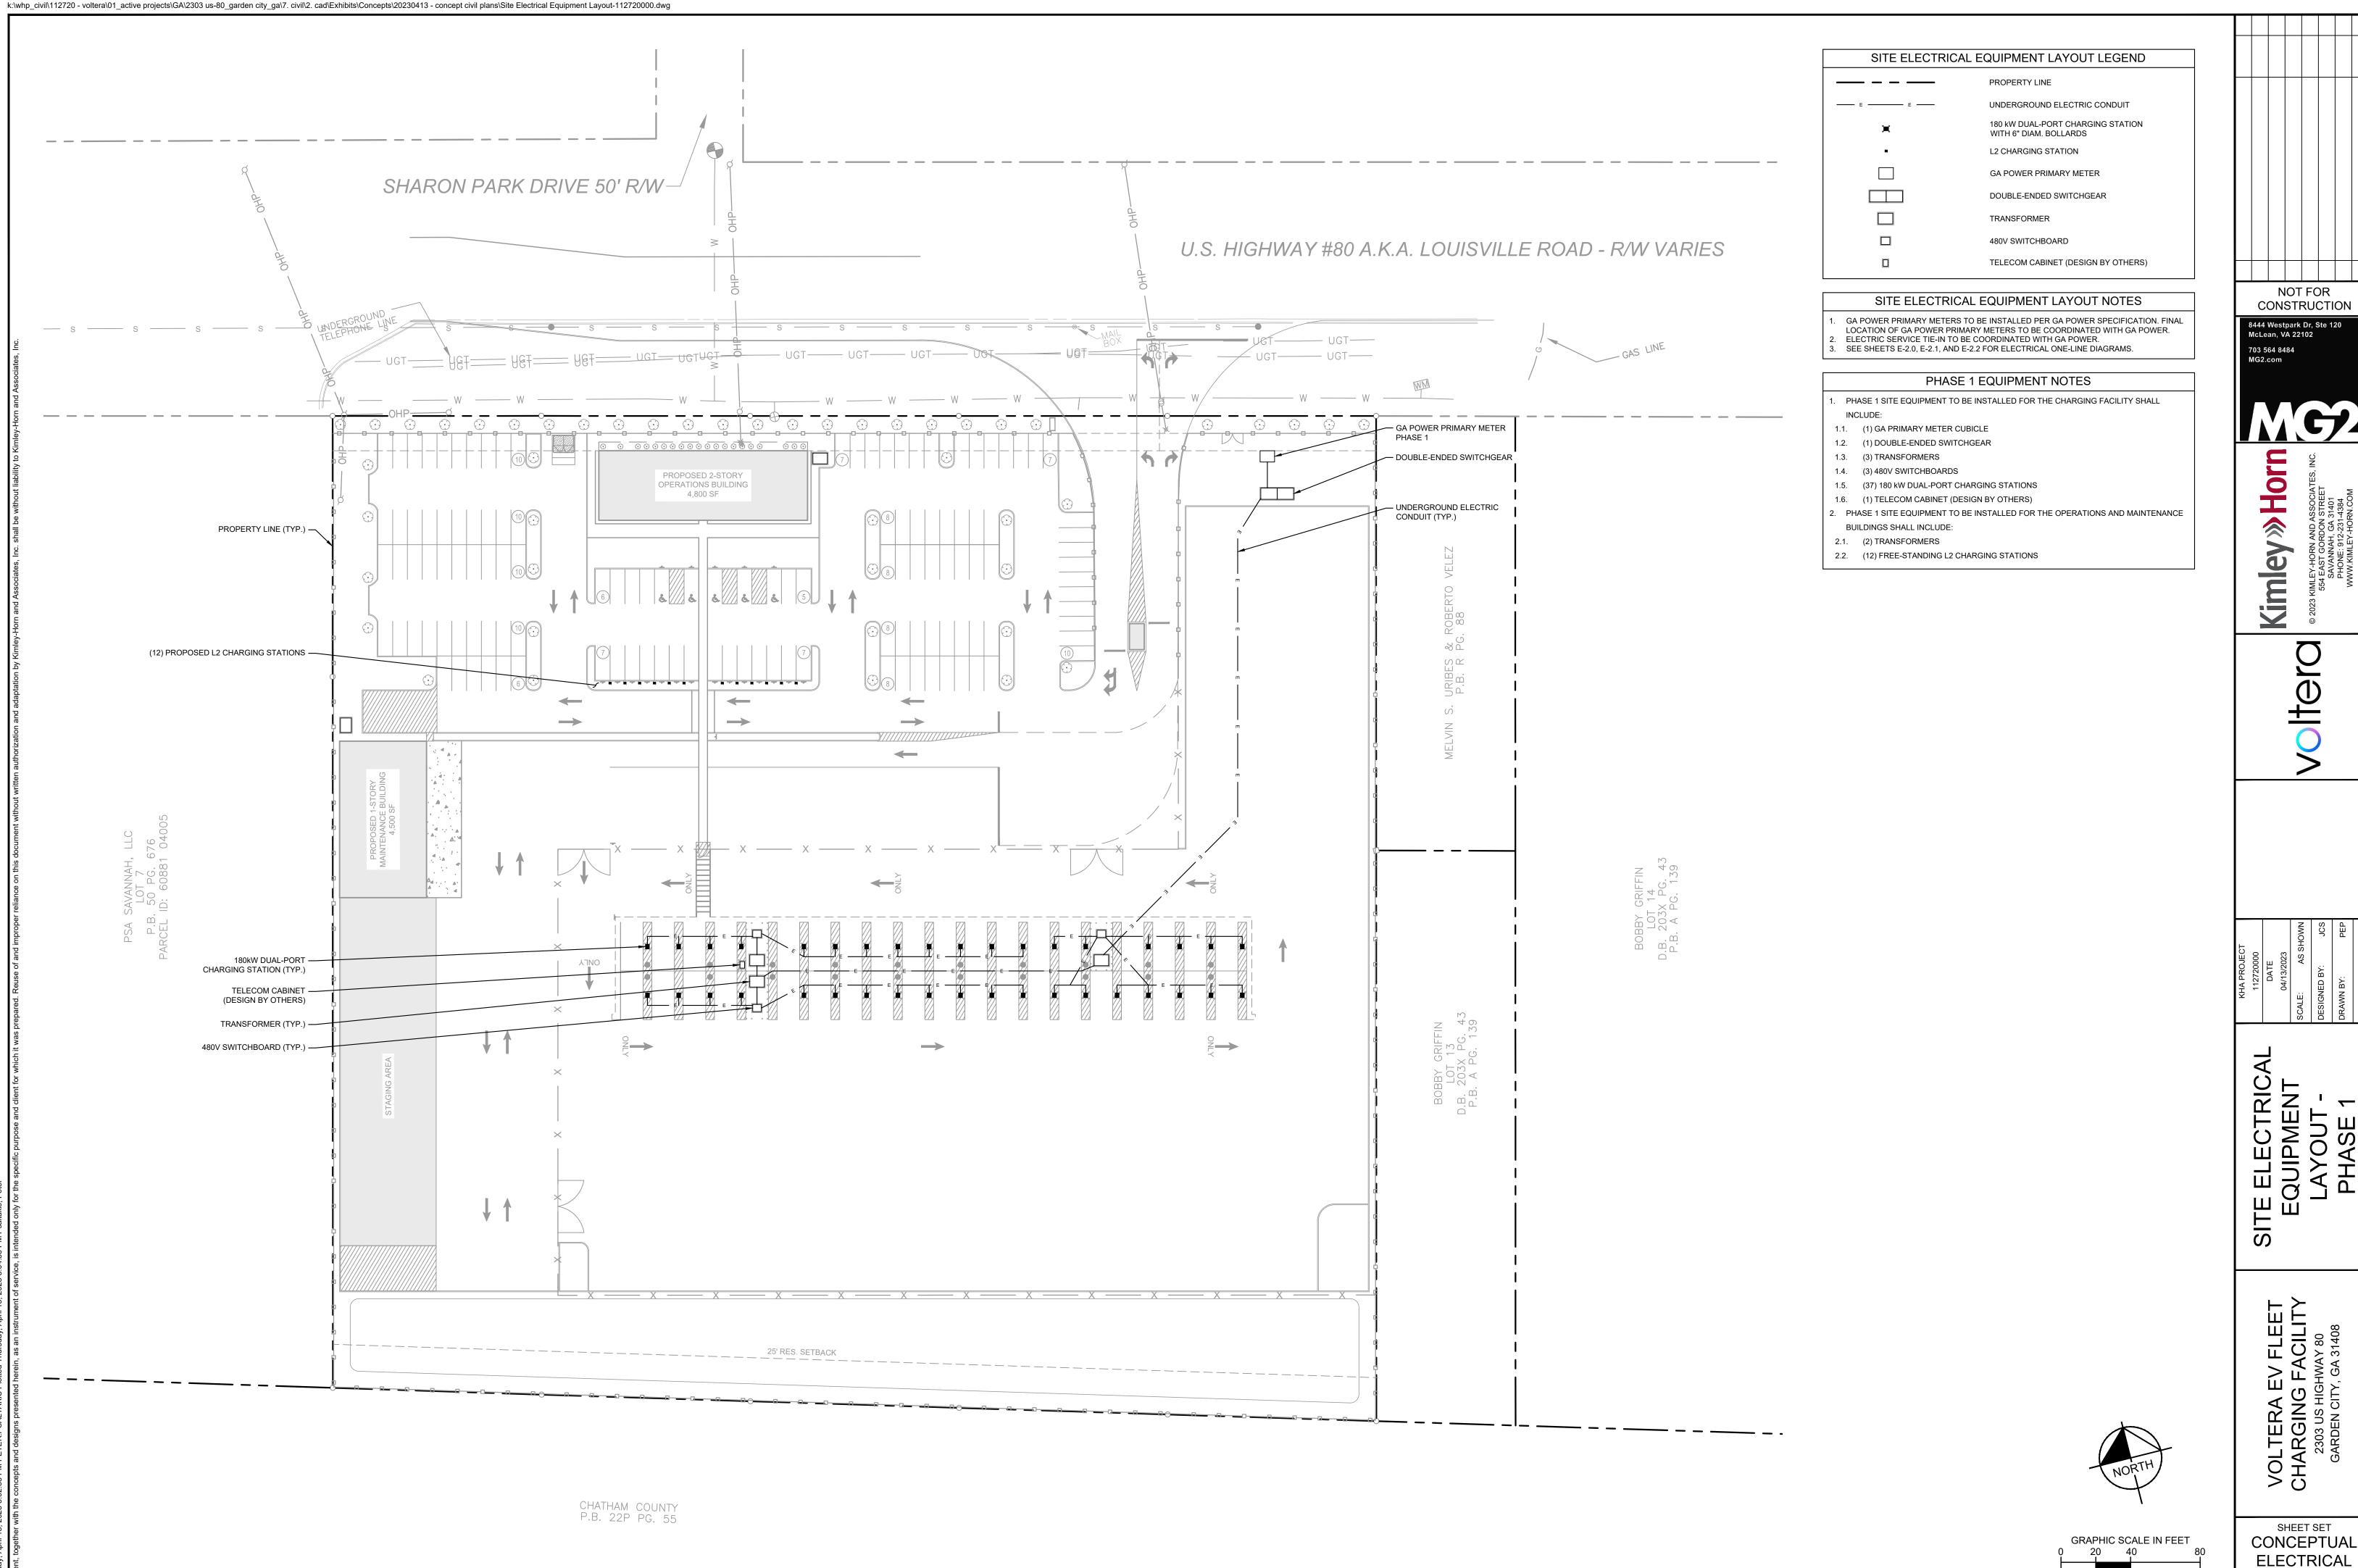
NOT FOR CONSTRUCTION 8444 Westpark Dr, Ste 120 McLean, VA 22102 703 564 8484

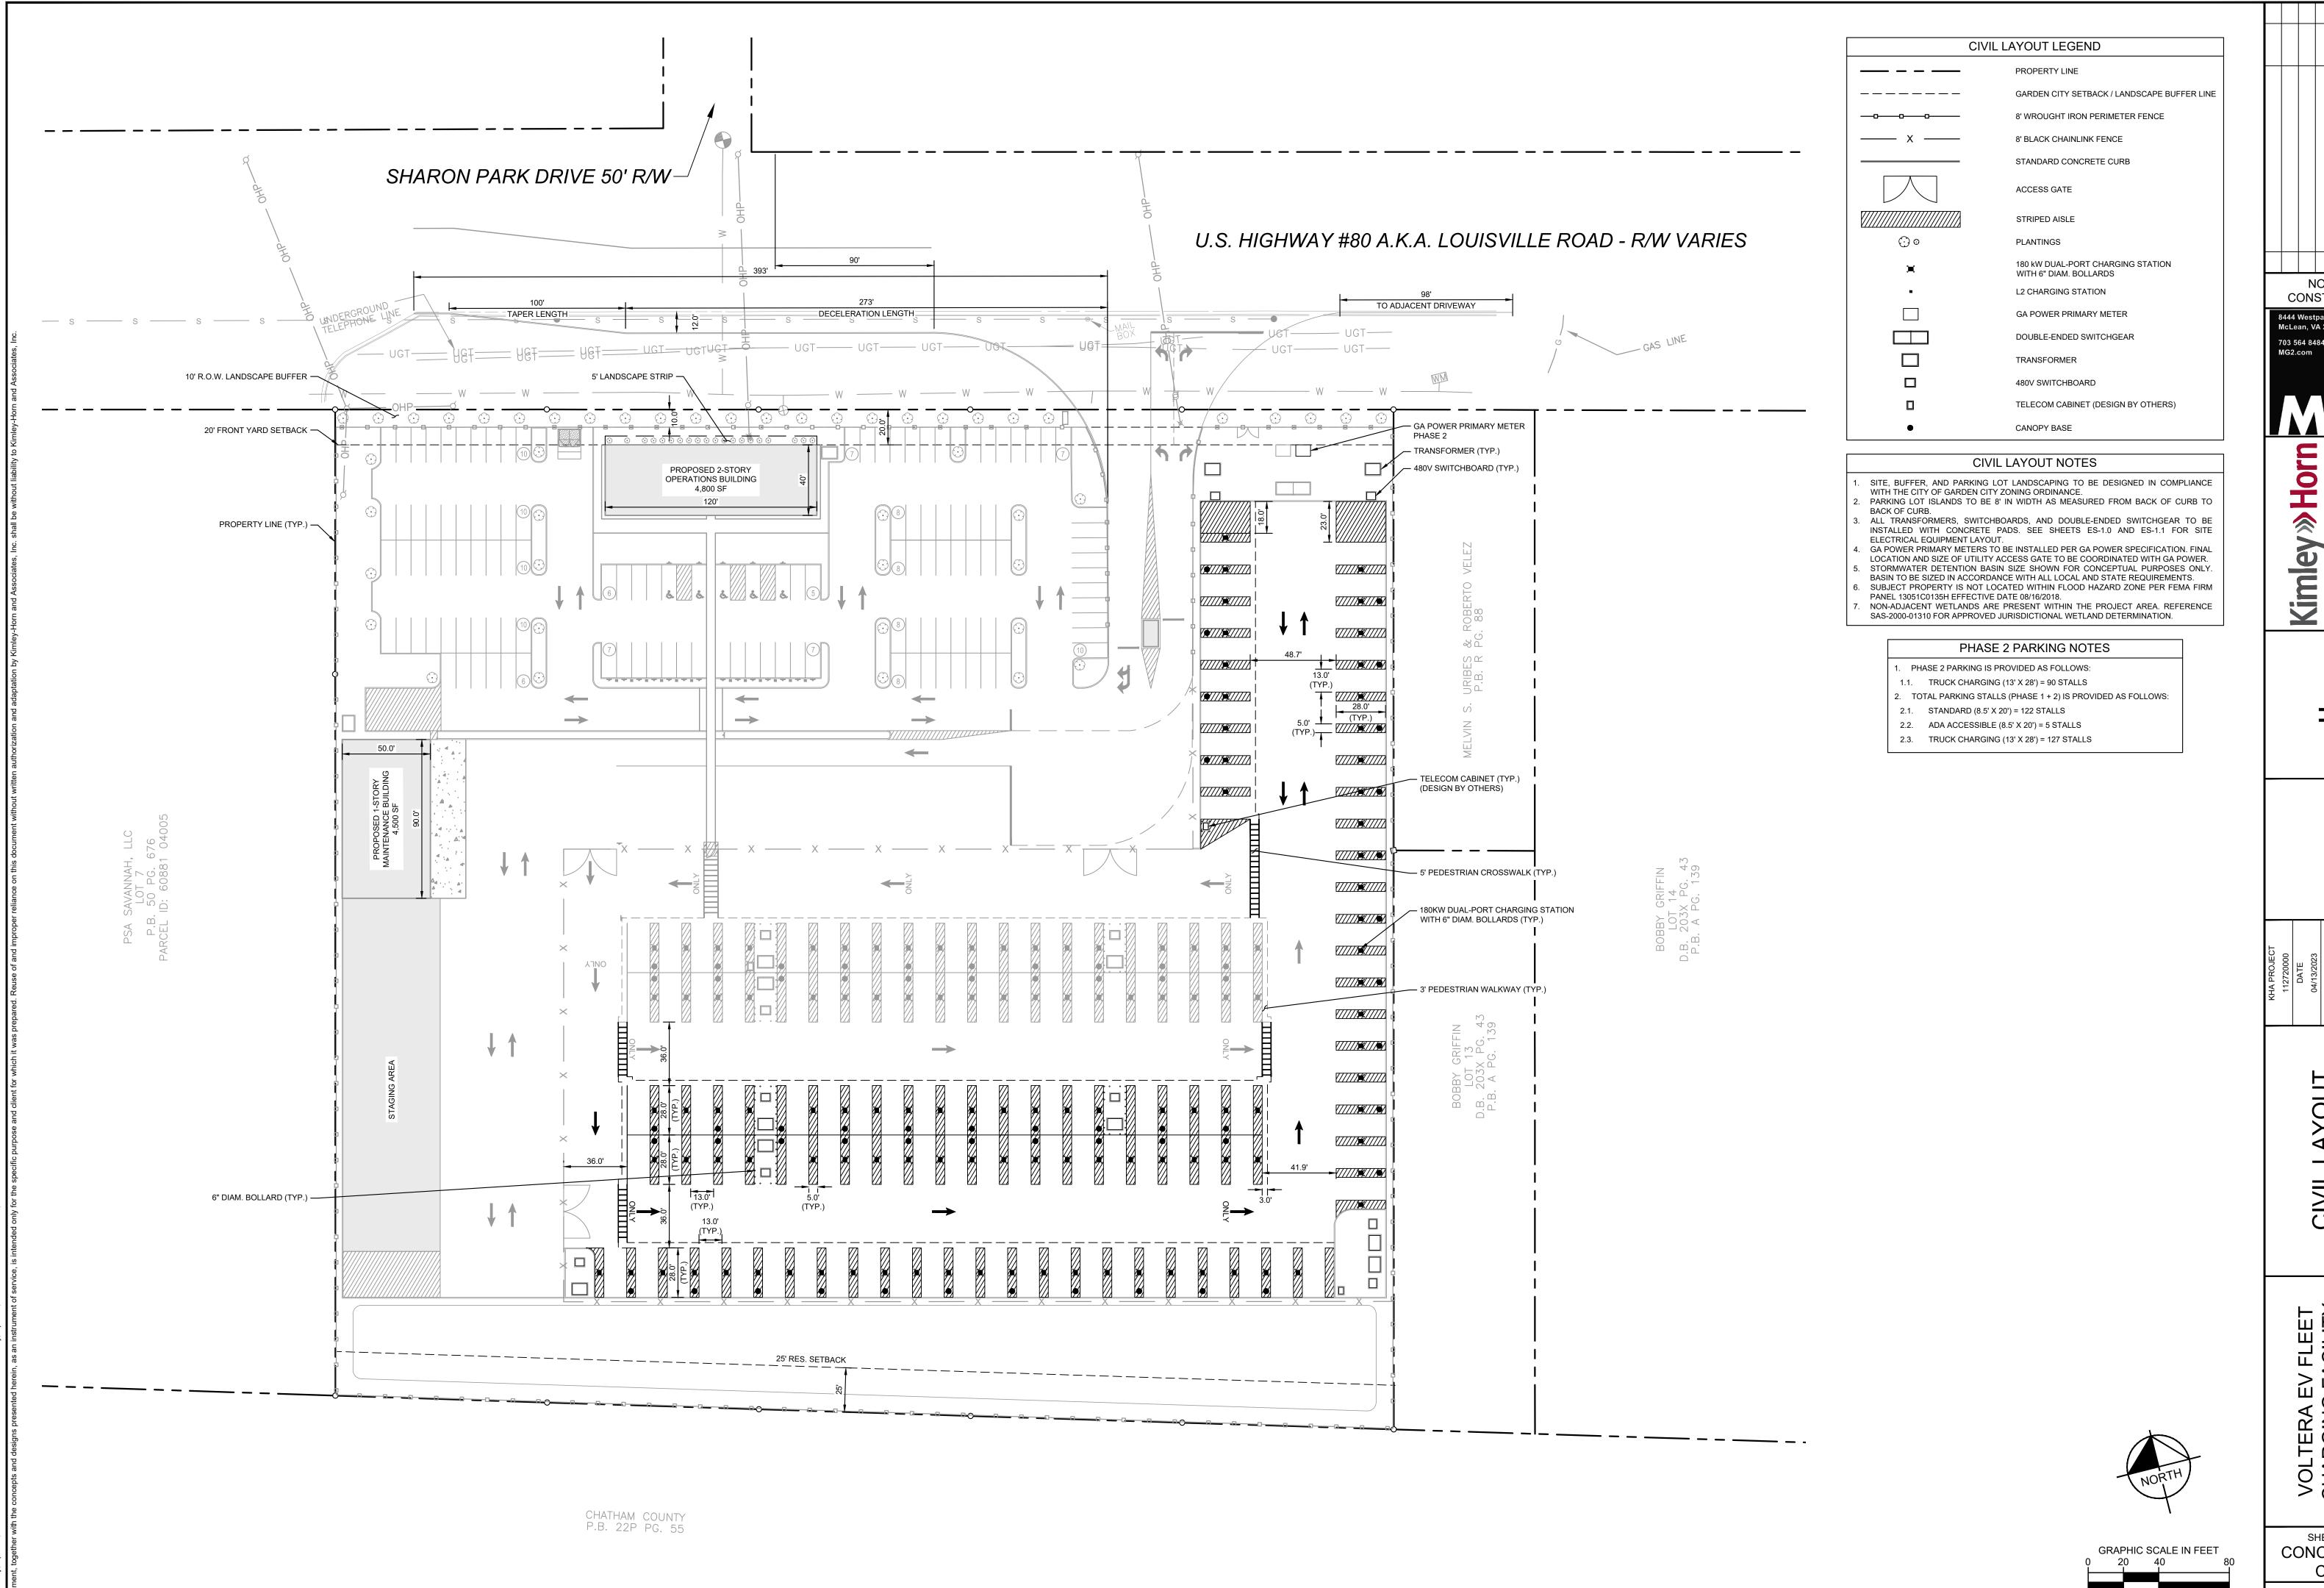LAYOUT PHASE 2

SHEET SET


CONCEPTUAL CIVIL SHEET NUMBER

C-3.1



ELECTRICAL

SHEET NUMBER ES-1.0

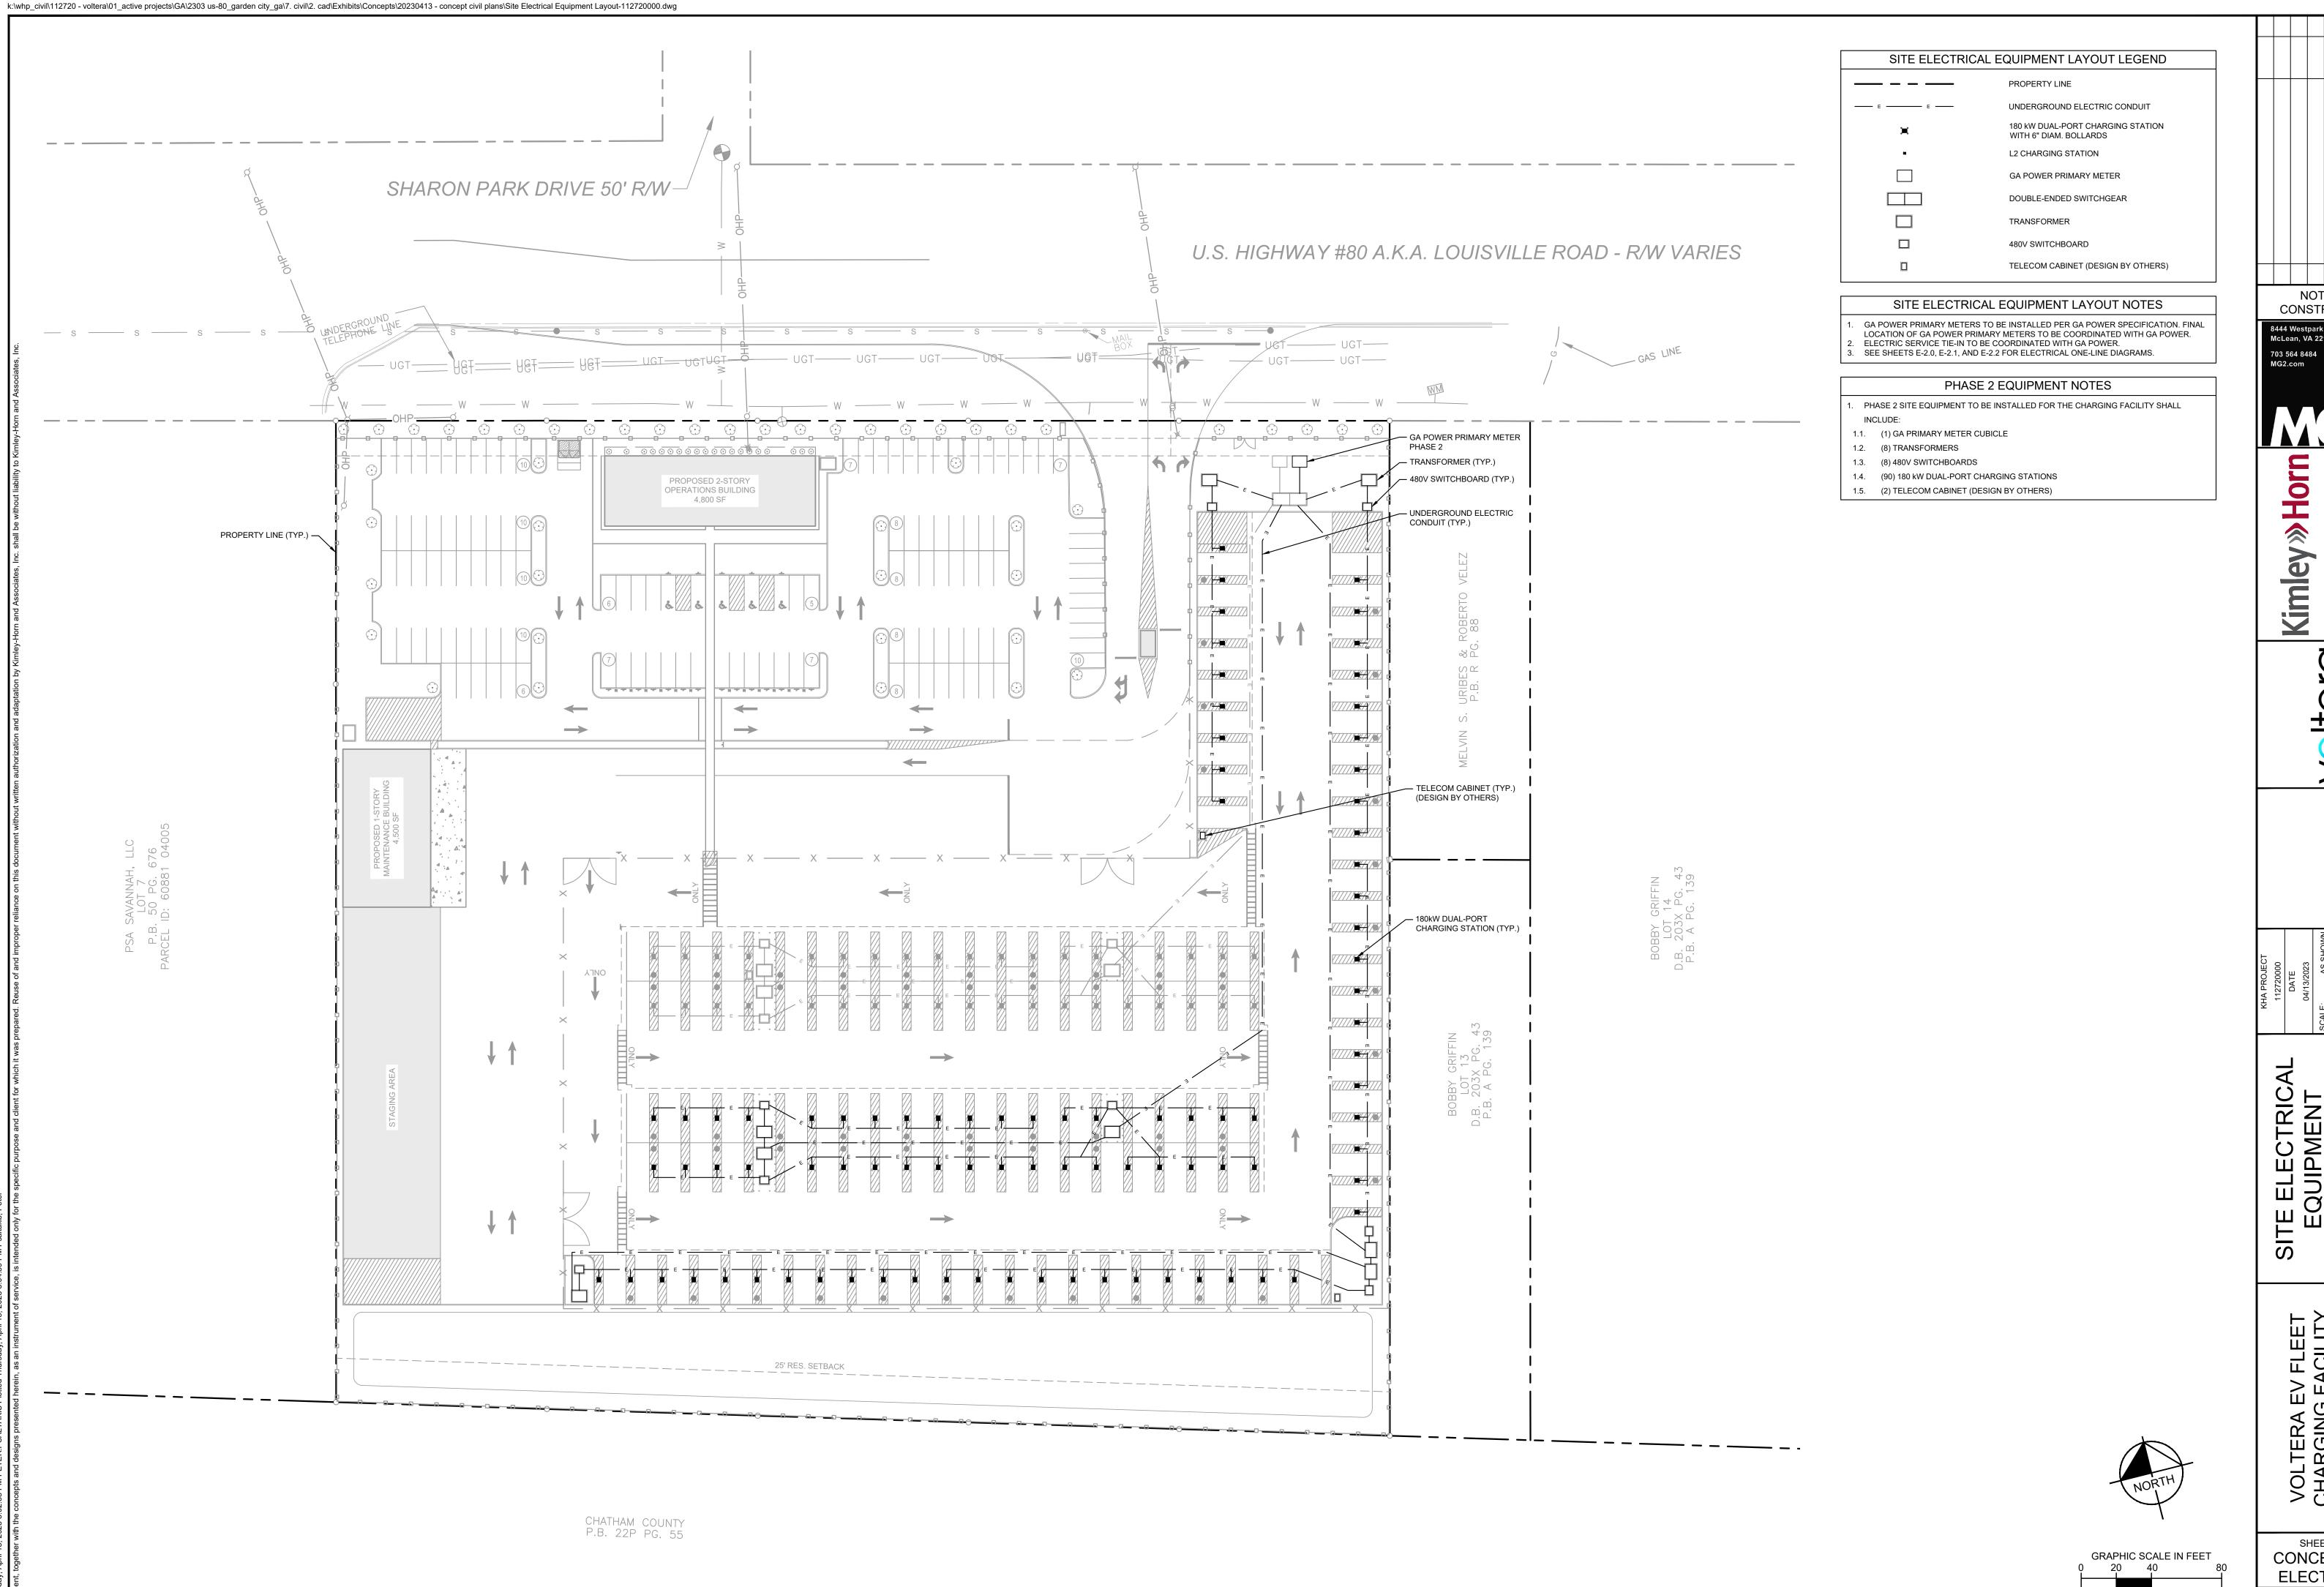

NOT FOR CONSTRUCTION


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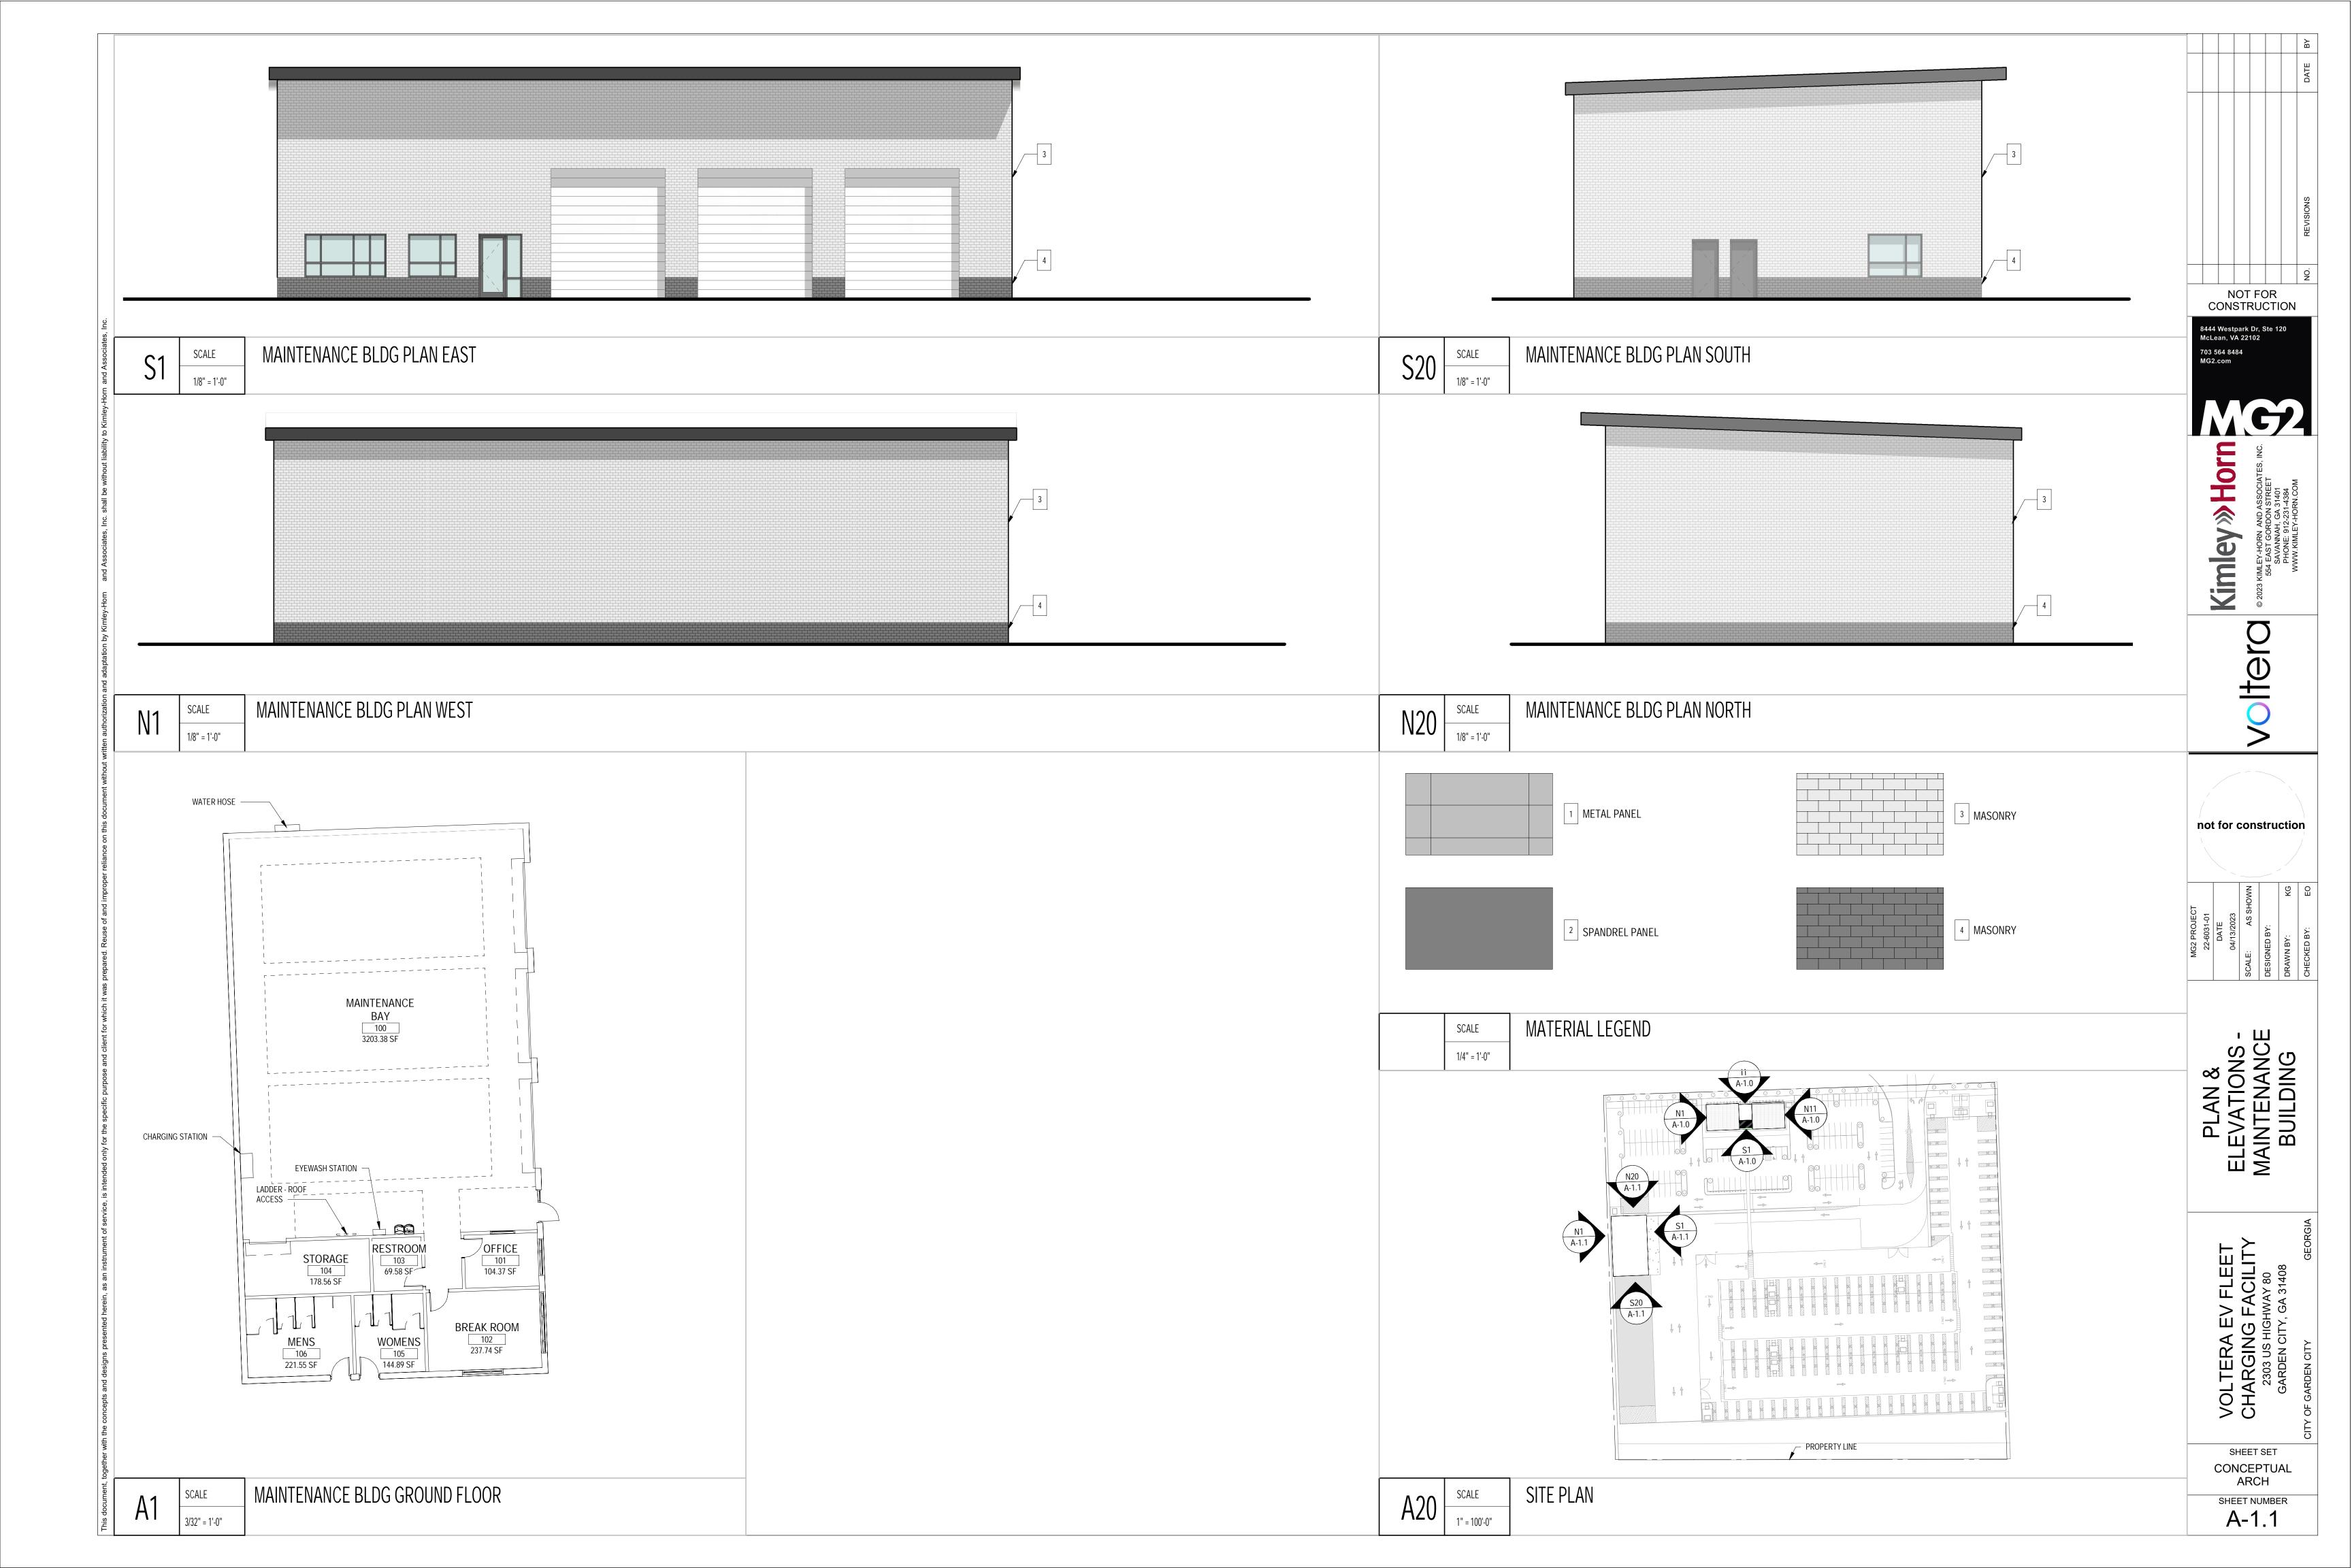
McLean, VA 22102 703 564 8484


SITE ELECTRICAL EQUIPMENT LAYOUT -PHASE 2

SHEET SET CONCEPTUAL ELECTRICAL SHEET NUMBER

ES-1.1



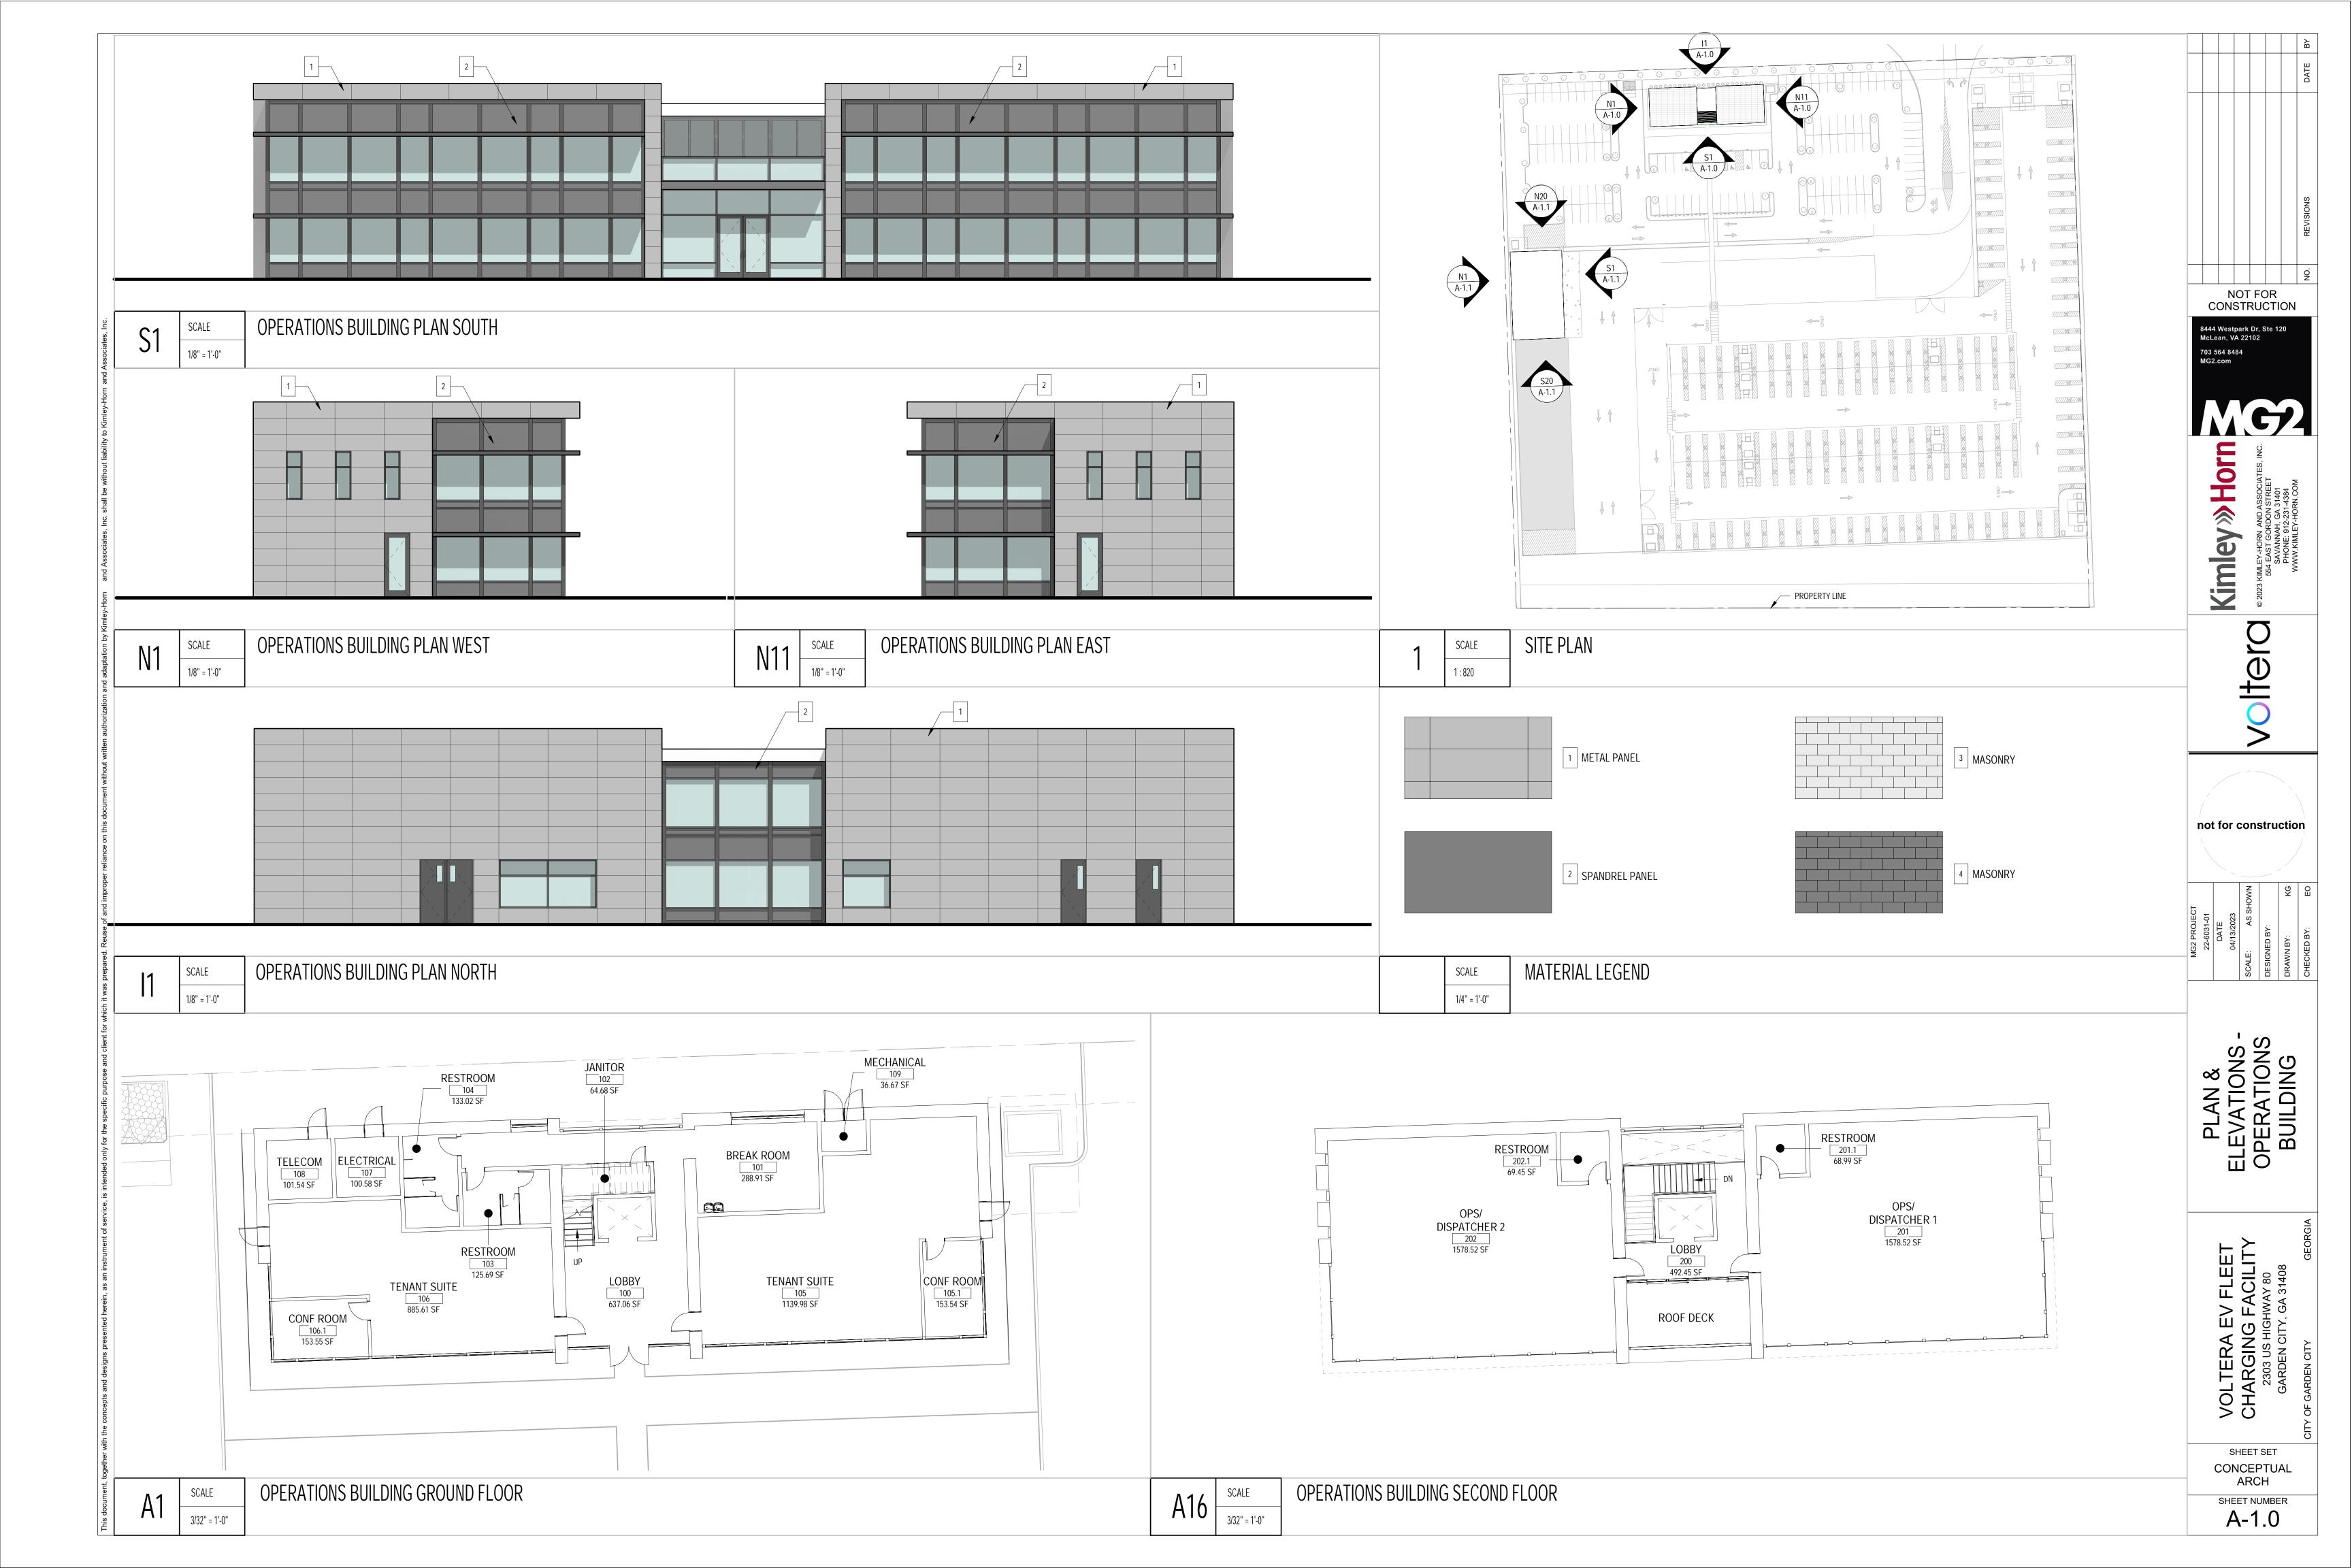

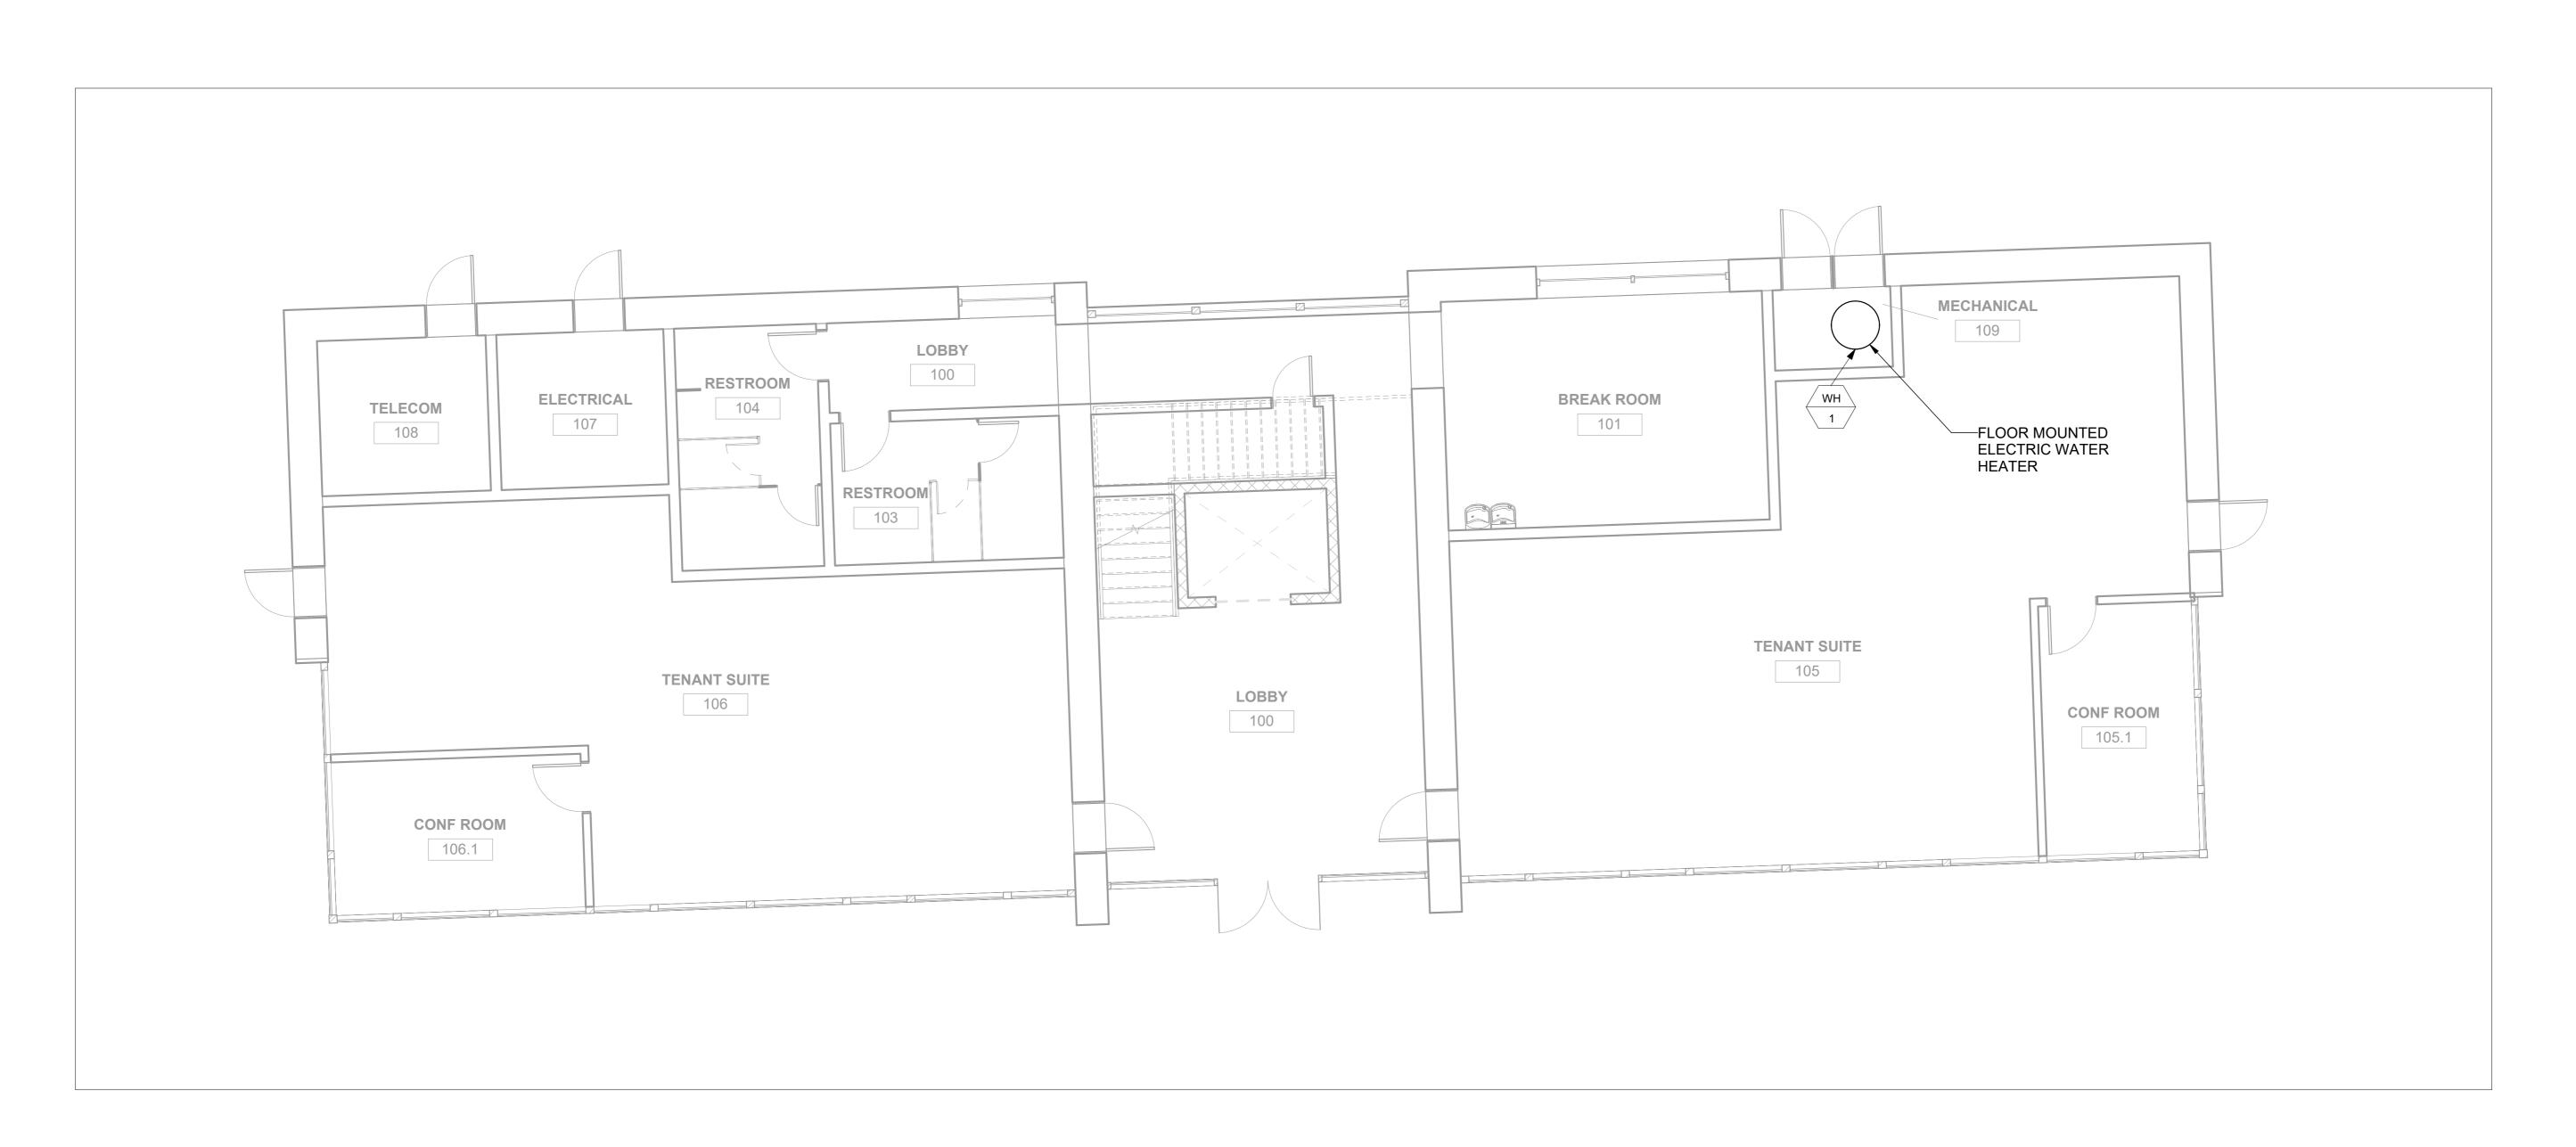

**OPERATIONS - LEVEL 1**3/16" = 1'-0"

NO. REVISIONS

DATE
BY

DATE
B

© 2023 KIMLEY-HORN AND ASSOCIATES, INC.

554 EAST GORDON STREET
SAVANNAH, GA 31401
PHONE: 912-231-4384
WWW.KIMLEY-HORN.COM

SCALE: 3/16" = 1'-0"
DESIGNED BY: DUA
DRAWN BY: DUA

OPERATIONS BUILDING IECHANICAL PLAN

TERA EV FLEET
ARGING FACILITY
2303 US HIGHWAY 80
SARDEN CITY, GA 31408

SHEET SET CONCEPTUAL MECHANICAL

SHEET NUMBER
M-1.0

#### PC2304: General Development Plan Review





#### **City of Garden General Development Plan Application**

□ Electronic

□ Paper

□ Both



#### **Development Information Development Name Property Address** Phased development? If yes, indicate proposed number of phases: □ Yes □ No Parcel ID **Total Site Acreage** Zoning 0.91 P-I-2 60988A02007 **Project Description** Water Supply **Sewage Disposal** □ Public □ Private □ Public □ Private **Applicant Information** Owner Name **Address Email Phone** Engineer/Surveyor ☐ Same as authorized agent □ Check here to receive staff review comments via email **Company Name** Contact (Individual Name) Phone Email **Authorized Agent (Requires Authorized Agent Form)** □ Check here to receive staff review comments via email **Company Name Contact (Individual Name)** Phone **Email** I understand that I will need to attend or be represented by a duly authorized agent at the meeting of the Planning Commission and that my application cannot be approved unless I am represented. Steven Carbone Print Name Date Signature **OFFICE USE ONLY** Received By **Date Received** Case Number Submittal Format Fee Amount Paid

**Invoice Number** 



#### **MEMORANDUM**

**To:** Garden City Planning Commission & Board of Appeals

From: Denise R. Grabowski, AICP, LEED AP, Planning Manager Consultant

**Date:** May 2, 2023

Re: PC 2319 – 1622 Dean Forest Road

Application Type	General Development Plan
	General Development Flan
Case Number	PC 2319
Applicant	Steve Car <mark>bone</mark>
Name of Project	Industrial Electro Mechanics
Property Address	1622 Dean Forest Road
Parcel IDs	60988A 02007
Area of Property	0.9 <mark>1 acres</mark>
Current Zoning	P-I-2, Planned Industrial
Proposed Land Use	M <mark>echanical sh</mark> op

#### **GENERAL INFORMATION**

Project Description: The applicant is proposing to construct a mechanical shop.

Pursuant to Section 90-43, Designation of P districts, a general development plan must be submitted for review and approval by the Planning Commission prior to development of the site. The general plan for a proposed P district shall include proposed uses and overall development standards and shall promote an environment of stable and desirable character in harmony with the established or proposed land use pattern in surrounding areas.

#### **FINDINGS**

Staff has determined this application is complete and contains all required information. In conformance with the City of Garden City Zoning Ordinance Section 90-48, the following factors are to be considered for a General Development Plan review:

Proposed uses and overall development plan
 The applicant is proposing to develop a mechanical shop, which is allowed in I-2 zoning.
 The site plan indicates portions of the stormwater infrastructure encroaching on the adjacent property (to the east). The applicant will provide verification of recorded

easements providing legal access to this infrastructure for maintenance prior to the issuance of construction permits.



- 2. Façade elevation plan indicating building orientation and scale; exterior construction materials, including texture and color; roof shape, window and door openings, porches, and balconies; architectural style or structure and the facade architectural treatment. The building is currently under design. The applicant intends to construct a light gray metal building that will be similar in color to adjacent buildings.
- 3. Fences, landscaping, and buffers.
  The property is surrounded by I-2 properties, so no buffers are required. A chain link fence will be provided along Morgan Road. The applicant has provided landscaping information, which includes the planting of oaks, cypress, and elm trees.
- 4. Driveway and parking orientation, in keeping with the established character in the area. Access to the property is via Morgan Road, a private road off Dean Forest Road. The applicant provided a copy of the warranty deed stating his legal access to the property via Morgan Road.
- 5. Scale, design, and location of exterior signs. Special sign restrictions may be required based on the location and character of the development and surrounding area.

  Any signage shall comply with the City of Garden City ordinances and will require a sign permit.

The applicant has provided the required information.

#### RECOMMENDATION

**Approval** of the General Development Plan.

#### Note:

Approval, if granted, by the Planning Commission only constitutes the initial step in the overall process and additional requirements still must be met prior to commencement of any construction activities. The Petitioner should note that final approval of the site plan will require City staff approval of the detailed engineering plans for the project through the City's standard process and a Land Disturbance Activity (LDA) Permit must be issued prior to construction. The Petitioner should also note that final approval of the site architectural plans will require City staff approval via its standard process and a building permit must be issued before vertical construction shall commence.

## SITE DEVELOPMENT PLANS

### FOR

# MORGAN ROAD INDUSTRIAL TRACT

GARDEN CITY, GEORGIA

Prepared for

INDUSTRIAL ELECTRO MECHANICS

### PROJECT DATA

OWNER/DEVELOPER:

1624 DEAN FOREST ROAD

24HR CONTACT:

STEVE CARBONE (912) 667-0998

0.92 ACRES

WAREHOUSE

0.51 AC.

15,070 SF

TAX MAP & PARCEL NUMBER: 60988A02007

ZONING CLASSIFICATION:


PROPOSED USE:

MPERVIOUS AREA:

DISTURBED AREA:

PARKING SPACES PROVIDED: 10 SPACES

PARKING SPACES REQUIRED: 10 SPACES

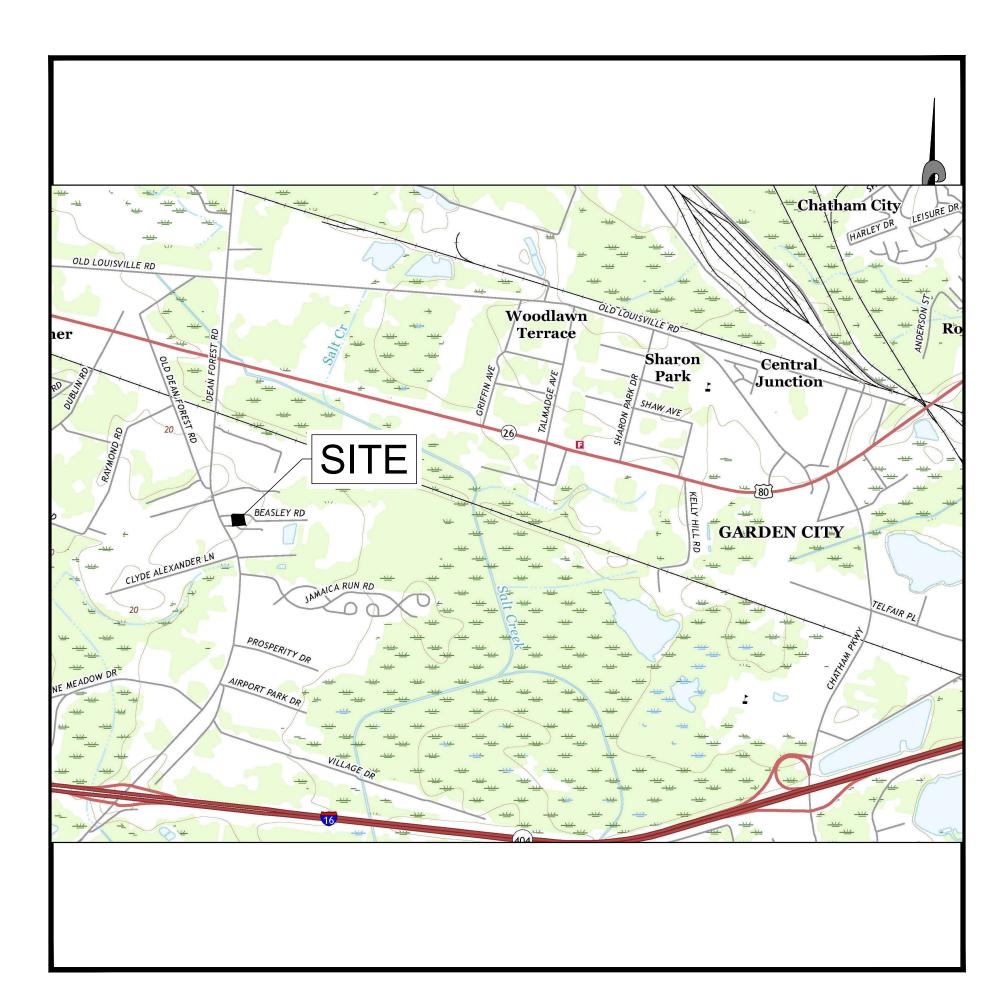

**VICINITY MAP** 



PROJECT LOCATION: 1622 DEAN FOREST ROAD GARDEN CITY, GEORGIA EMC PROJECT# 22-0039 FEBRUARY 2023



## EMC ENGINEERING SERVICES, INC.

**ENVIRONMENTAL- MARINE - CIVIL - SURVEY** 

Sheet List Table	
Sheet Number	Sheet Title
1	COVER SHEET
2	GENERAL NOTES
3	EXISTING CONDITIONS & CLEARING PLAN
4	STAKING & UTILITY PLAN
5	SEPTIC SYSTEM PLAN
6	PAVING, GRADING & DRAINAGE PLAN
7	LANDSCAPE PLAN
8	EROSION, SEDIMENTATION & POLLUTION CONTROL PLAN
9	CONSTRUCTION DETAILS
10	CONSTRUCTION DETAILS
11	CONSTRUCTION DETAILS

#### UTILITY LOCATION DISCLAIMER

PERSONNEL. THE SURVEYOR MAKES NO GUARANTEE THAT THE UTILITIES SHOWN THE EXACT LOCATION INDICATED, ALTHOUGH HE DOES CERTIFY THAT THEY ARE

REVISION	DESCRIPTION	DATE
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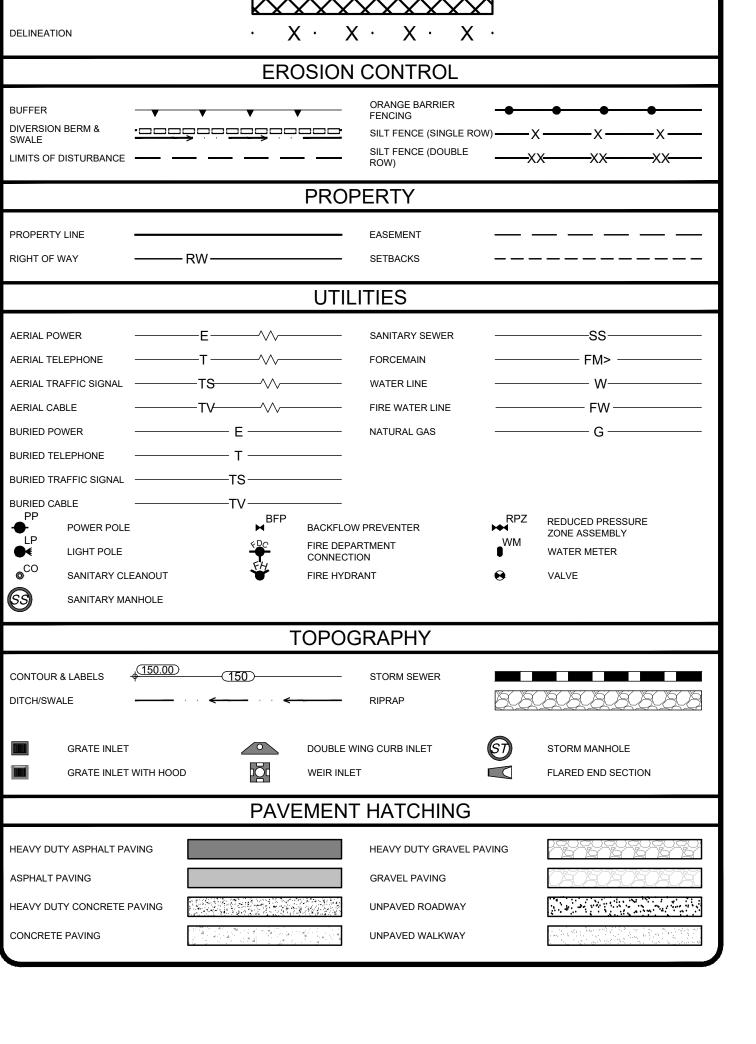
#### EMC ENGINEERING SERVICES, INC. 27 CHATHAM CENTER SOUTH, SUITE A

PHONE: (912) 232-6533 savannah@emc-eng.com

### **GENERAL NOTES**

- 1. IT WILL BE THE RESPONSIBILITY OF THE CONTRACTOR TO INSURE THAT ALL REQUIRED PERMITS ARE OBTAINED PRIOR TO THE COMMENCEMENT OF
- ALL CONSTRUCTION SHALL BE PERFORMED IN ACCORDANCE WITH THE CITY OF GARDEN CITY SPECIFICATIONS.
- PRIOR TO INSTALLATION OF ANY UTILITY LINES, THE CONTRACTOR SHALL GIVE THE UTILITY COMPANIES THREE (3) WORKING DAYS NOTICE TO ALLOW TIME FOR EXISTING UTILITIES TO BE STAKED. BEFORE CALLING (811) THE CONTRACTOR SHALL HAVE THE FOLLOWING INFORMATION READY: COUNTY, TOWN, LOCATION, NEAREST STREET INTERSECTIONS, TYPE OF WORK (SEWER, WATER, PAVING, ETC.) YOUR COMPANY NAME, TELEPHONE NUMBER, OWNER'S NAME, DATE AND TIME YOU EXPECT TO COMMENCE CONSTRUCTION, AND WHERE AND HOW YOU CAN BE REACHED AND THE BEST TIME TO CONTACT YOU. THE CONTRACTOR SHALL EXERCISE CAUTION WHEN CROSSING AN UNDERGROUND UTILITY, WHETHER SHOWN ON THE PLAN OR LOCATED BY THE UTILITY COMPANY. ALL UTILITIES WHICH INTERFERE WITH THE PROPOSED CONSTRUCTION SHALL BE RELOCATED BY THE RESPECTIVE UTILITY COMPANIES, AND THE CONTRACTOR SHALL COOPERATE WITH THEM DURING RELOCATION OPERATIONS. THE CONTRACTOR SHALL NOTIFY THE ENGINEER OF ANY VARIANCES PRIOR TO COMMENCEMENT OF WORK OR PURCHASING ANY MATERIALS.
- 4. ALL KNOWN UTILITY FACILITIES ARE SHOWN SCHEMATICALLY ON THE PLANS AND ARE NOT NECESSARILY ACCURATE AS TO PLAN OR ELEVATION. UTILITY FACILITIES SUCH AS SERVICE LINES OR UNKNOWN FACILITIES NOT SHOWN ON THE PLANS WILL NOT RELIEVE THE CONTRACTOR OF HIS RESPONSIBILITIES, EXCEPT AS NOTED BELOW. THE CONTRACTOR WILL NOT BE RESPONSIBLE FOR THE COST OF REPAIRS TO DAMAGED UTILITY FACILITIES OTHER THAN SERVICE LINES FROM STREET MAINS TO ABUTTING PROPERTY WHEN SUCH FACILITIES ARE NOT SHOWN ON THE PLANS AND THEIR EXISTENCE IS UNKNOWN TO THE CONTRACTOR PRIOR TO THE DAMAGES OCCURRING PROVIDING THE ENGINEER DETERMINES THE CONTRACTOR HAS OTHERWISE FULLY COMPLIED WITH THE SPECIFICATIONS.
- 5. IT IS THE OBLIGATION OF THE CONTRACTOR TO MAKE HIS OWN INTERPRETATION OF ALL SURFACE AND SUBSURFACE DATA AS TO THE NATURE AND EXTENT OF THE MATERIALS TO BE EXCAVATED. THE INFORMATION SHOWN ON THESE PLANS AND SPECIFICATIONS DOES NOT IN ANY WAY GUARANTEE THE AMOUNT OR NATURE OF THE MATERIAL WHICH MAY BE ENCOUNTERED.
- 6. FILL SHALL CONSIST OF SUITABLE MATERIALS WHICH ARE GENERALLY COMPOSED OF SANDS, CLAY-SAND MIXTURES, AND SILT-SAND MIXTURES AND ARE FREE OF ROOTS, TRASH, AND OTHER DELETERIOUS MATERIAL. CLAYS, SILTS, AND ORGANIC SOILS SHALL BE CONSIDERED AS UNSUITABLE MATERIALS.
- 7. THE CONTRACTOR SHALL BE RESPONSIBLE FOR LOCATION AND FURNISHING THE BORROW MATERIAL NECESSARY FOR THE CONSTRUCTION OF THIS PROJECT. BORROW MATERIAL SHALL BE CAPABLE OF BEING SHAPED AND COMPACTED TO THE REQUIRED DENSITIES SPECIFIED.
- 8. A COMPLETE PERMIT SET OF PLANS MUST BE KEPT ON SITE AT ALL TIMES.
- 9. PROTECTION OF EXCAVATED AREAS: TEMPORARY FENCING SHALL BE USED AROUND OPEN EXCAVATIONS AT ALL TIMES, EXCEPT AS NECESSARY FOR IMMEDIATE CONSTRUCTION. WHEN WORK IS NOT IN PROGRESS, FENCING SHALL ENCLOSE EXCAVATED AREAS. UTILITY TRENCHES SHALL BE BACKFILLED TO GRADE AT THE END OF THE DAY, ALLOWING FOR A MAXIMUM OF 10' (FENCE-PROTECTED) TRENCH TO REMAIN OPEN.
- 10. THIS PARCEL LIES WITHIN A ZONE X AS SHOWN ON THE FEMA FLOOD INSURANCE MAP 13051C PANEL 0129G EFFECTIVE DATE AUGUST 16, 2008.
- 11. NO WETLANDS OR STATE WATERS ON THE SITE.
- 12. HORIZONTAL DATUM IS GEORGIA STATE PLANE COORDINATE SYSTEM OF 1985, EAST ZONE, NORTH AMERICAN DATUM OF 1983 (NAD88). VERTICAL DATUM IS NORTH AMERICAN VERTICAL DATUM OF 1988 (NAVD88).

DEMOLITION  AREA  DELINEATION  EROSION CONTROL  BUFFER DIVERSION BERM & SILT FENCE (SINGLE ROW) SILT FENCE (DOUBLE ROW) XX XX XX  PROPERTY  PROPERTY  PROPERTY  PROPERTY  BUTILITIES  AERIAL POWER BUTILITIES  AERIAL TELEPHONE T PORCEMAIN T PORCEMAI
DELINEATION  EROSION CONTROL  BUFFER  DIVERSION BERM 8 SWALE  LIMITS OF DISTURBANCE  PROPERTY  PROPERTY  PROPERTY  PROPERTY  BUTILITIES  AERIAL POWER  AERIAL TRAFFIC SIGNAL  TS  WATER LINE  BURIED POWER  BURIED POWER  BURIED TRAFFIC SIGNAL  TS  BURIED CABLE  TV  PP  PP  POWER POLE  LIGHT POLE  CONNECTION  WATER LINE  WM  WATER METER  ZONE ASSEMBLIY  VALVE
EROSION CONTROL  BUFFER DIVERSION BERM & SWALE LIMITS OF DISTURBANCE  PROPERTY  PROPERTY  PROPERTY   EASEMENT RIGHT OF WAY  RW  SETBACKS   UTILITIES   AERIAL POWER  AERIAL TRAFFIC SIGNAL TS WATER LINE  WATER LINE  WATER LINE  WATER LINE  WATER METER  BURIED POWER  BURIED CABLE TV  POWER POLE  PP POWER POLE  LIGHT POLE  CO SANITARY SEVENTER  NATURAL GAS  G  RPZ REDUCED PRESSURE ZONE ASSEMBLY WATER METER WATER LINE  RPZ REDUCED PRESSURE ZONE ASSEMBLY WATER METER CONNECTION WATER METER WWM WATER METER CONNECTION WATER METER VALVE
BUFFER DIVERSION BERM & SILT FENCE (SINGLE ROW)  WALE LIMITS OF DISTURBANCE  PROPERTY  PROPERTY  PROPERTY  PROPERTY  BURISH TOF WAY  AERIAL POWER  AERIAL TELEPHONE  T  AERIAL TRAFFIC SIGNAL  TS  BURISH TRAFFIC SIGNAL  TS  TRAFFIC SIGNAL  TRAFFIC SIGNAL  TS  TRAFFIC SIGNAL  TS  TRAFFIC SIGNAL  TS  TRAFFIC SIGNAL  TS  TRAFFIC SIG
FENCING SWALE SILT FENCE (SINGLE ROW) SILT FENCE (SINGLE ROW) XX XX XX  XX  XX  XX  XX  XX  XX  XX
PROPERTY LINE RIGHT OF WAY RW SETBACKS  UTILITIES  AERIAL POWER -E
AERIAL POWER E
UTILITIES  AERIAL POWER
AERIAL POWER  E  V  SANITARY SEWER  SS  AERIAL TELEPHONE  T  V  FORCEMAIN  FM>  AERIAL TRAFFIC SIGNAL  TS  WATER LINE  W  AERIAL CABLE  TV  FIRE WATER LINE  BURIED POWER  BURIED TELEPHONE  T  BURIED TRAFFIC SIGNAL  TS  BURIED CABLE  PP  POWER POLE  LP  LIGHT POLE  CO  SANITARY SEWER  SS  FORCEMAIN  FM>  FM>  FM>  FW  ATTRAL GAS  G  FIRE WATER LINE  FW  NATURAL GAS  G  RPZ  REDUCED PRESSURE ZONE ASSEMBLY  WM  WATER METER  VALVE
AERIAL TELEPHONE T
©CO SANITARY CLEANOUT FIRE HYDRANT • VALVE
TOPOGRAPHY
CONTOUR & LABELS  DITCH/SWALE  STORM SEWER  RIPRAP
GRATE INLET  DOUBLE WING CURB INLET  STORM MANHOLE  WEIR INLET  FLARED END SECTION
PAVEMENT HATCHING
HEAVY DUTY ASPHALT PAVING  ASPHALT PAVING  GRAVEL PAVING  UNPAVED ROADWAY  CONCRETE PAVING  UNPAVED WALKWAY





### UTILITY LOCATION DISCLAIMER


THE UTILITIES ARE SHOWN AS PER THE LOCATION OF POLES, MANHOLES, VALVES, PEDESTALS, ETC., EXISTING DRAWINGS AND INFORMATION PROVIDED BY UTILITY PERSONNEL. THE SURVEYOR MAKES NO GUARANTEE THAT THE UTILITIES SHOWN COMPRISE ALL SUCH UTILITIES IN THE AREA, EITHER IN SERVICE OR ABANDONED. THE SURVEYOR FURTHER DOES NOT WARRANT THAT THE UTILITIES SHOWN ARE THE EXACT LOCATION INDICATED, ALTHOUGH HE DOES CERTIFY THAT THEY ARE LOCATED AS ACCURATELY AS POSSIBLE FROM INFORMATION AVAILABLE


DRAWN BY: CFM DESIGNED BY: ABM SURVEYED BY: EMC SURVEY DATE: 06/30/2022 CHECKED BY: ABM SCALE: 1" = #### DATE: FEB., 2023

MORGAN

### ### 0' GRAPHIC SCALE: 1" = ####

SHEET

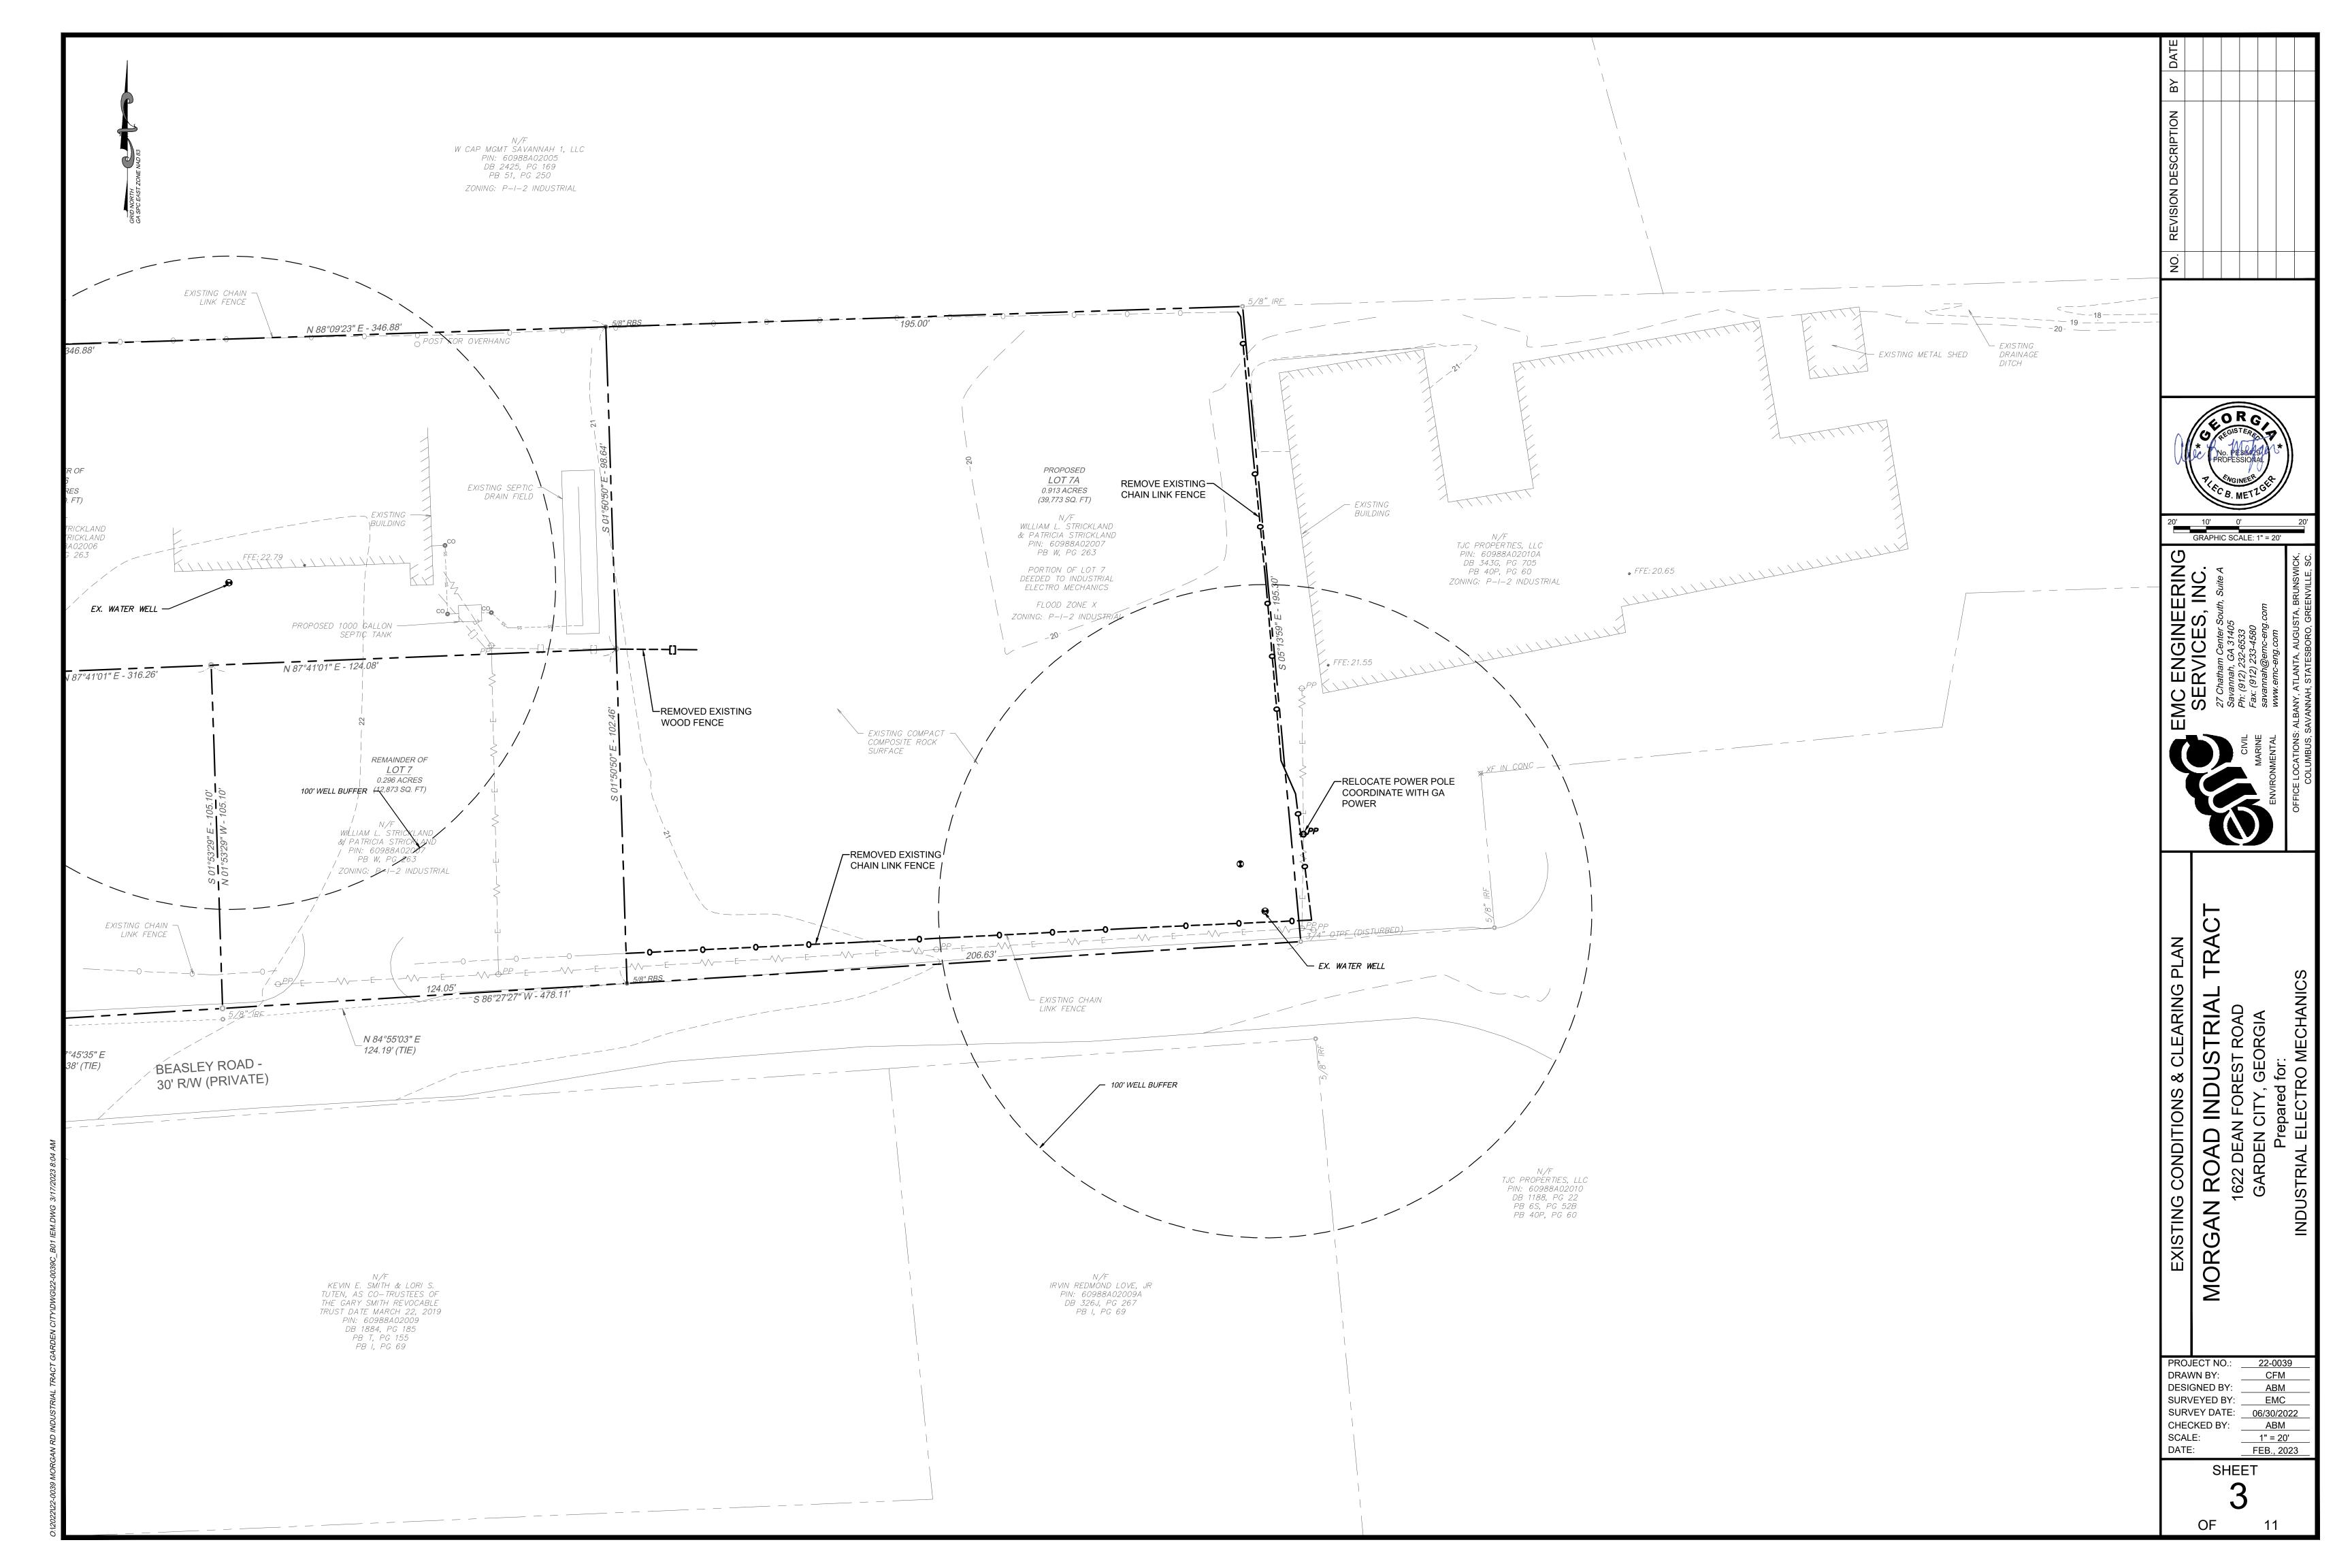

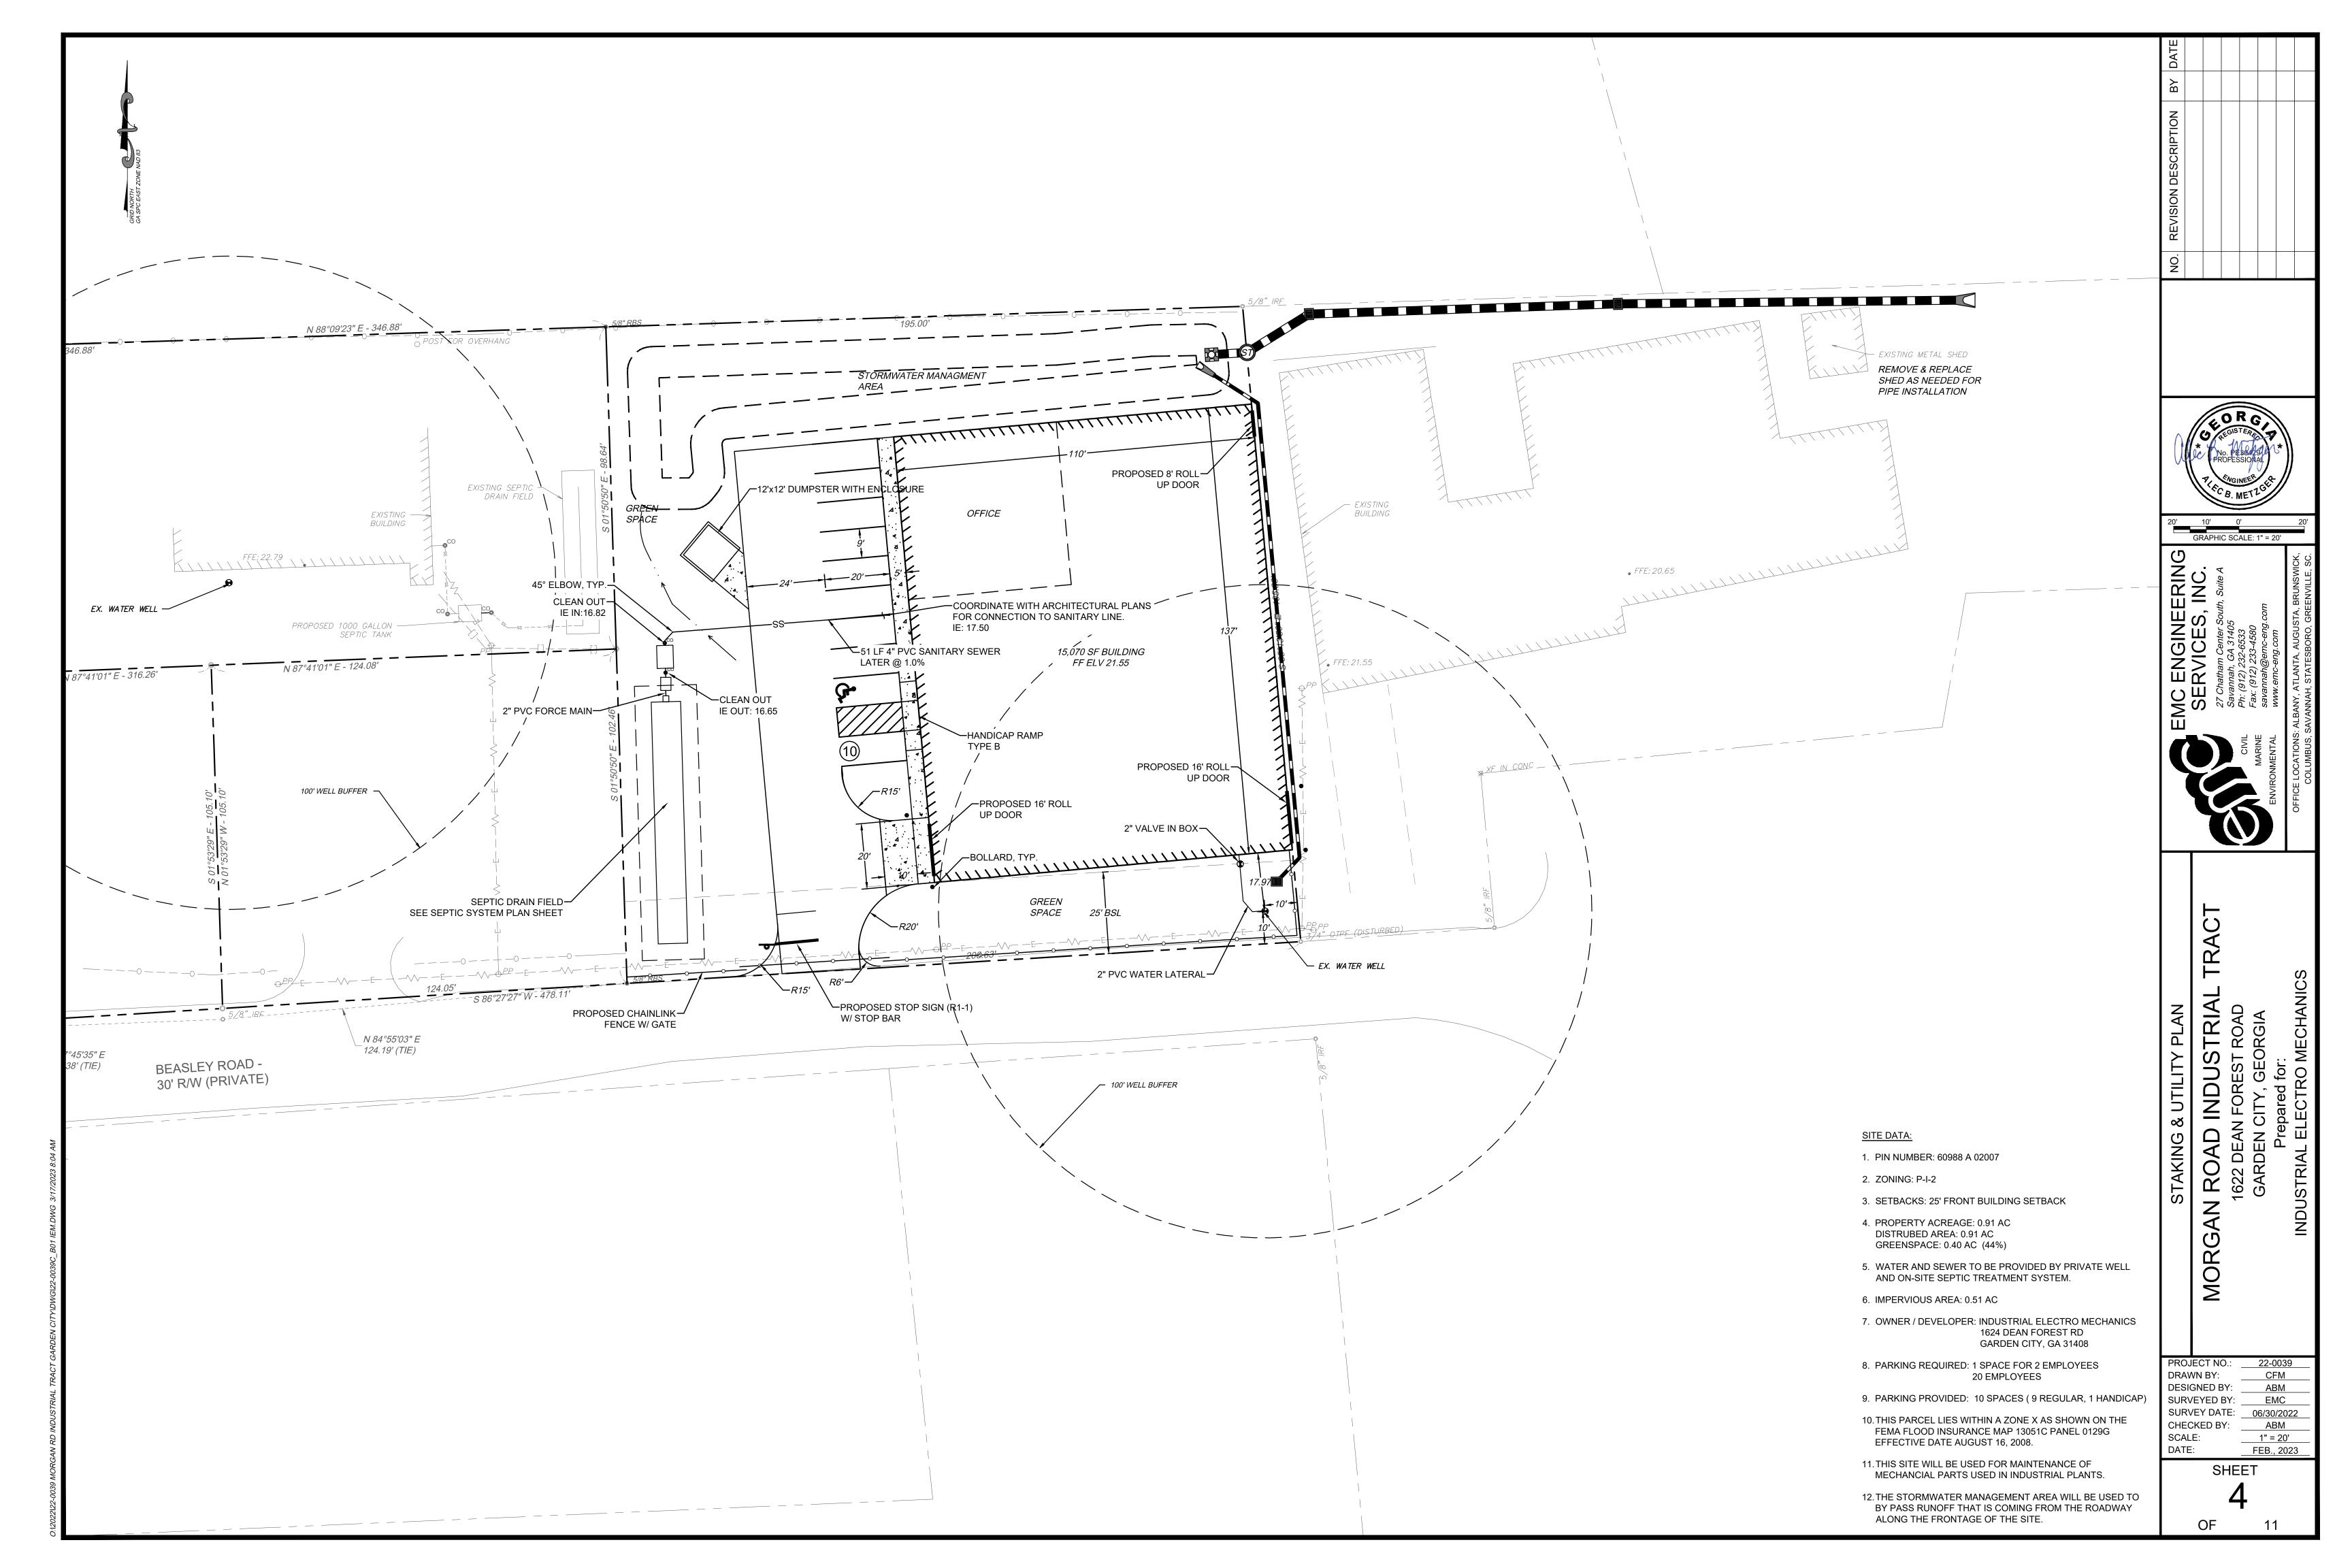

ABSORPTION FIELDS SHALL BE INSTALLED IN AREAS PROTECTED FROM EXCESSIVE SURFACE WATER, PONDING OR RUNOFF, INCLUDING BUT NOT LIMITED TO STORM WATER AND DISCHARGE FROM BUILDING GUTTERS. ABSORPTION FIELDS SHALL NOT BE INSTALLED WHERE SLOPES EXCEED 25% UNLESS THE RESULTS OF SPECIAL INVESTIGATIONS DEMONSTRATE THAT THE SLOPE LIMITATION CAN BE OVERCOME BY DESIGN OR SITE MODIFICATION. ANY SITE MODIFICATION PLAN MUST BE APPROVED BY THE LOCAL COUNTY BOARD OF HEALTH PRIOR TO MODIFICATIONS BEING CARRIED OUT. THERE SHALL BE A MINIMUM OF 24 INCHES OF VERTICAL SEPARATION FROM THE ABSORPTION FIELD TRENCH BOTTOM TO ANY SEASONAL GROUNDWATER TABLE, ROCK OR IMPERVIOUS SOIL LAYER. GREATER VERTICAL SEPARATION DISTANCES MAY BE REQUIRED IF SPECIAL INVESTIGATIONS INDICATE A POTENTIAL FOR GROUNDWATER CONTAMINATION. ON LOTS OR PARCELS OF LAND LESS THAN 3 ACRES, THE MAXIMUM PERCOLATION RATE SHALL NOT EXCEED 90 MINUTES PER INCH.

IF PROPERTIES ARE SERVED BY INDIVIDUAL WATER SUPPLY SYSTEMS, THE ABSORPTION FIELD SHALL BE INSTALLED NOT LESS THAN 50 FEET FROM PROPERTY LINES UNLESS WELLS AND ON-SITE SEWAGE MANAGEMENT SYSTEMS ARE ALREADY IN PLACE ON SURROUNDING PROPERTY AND THE REQUIRED 100 FEET SEPARATION DISTANCE BETWEEN WELLS AND ABSORPTION FIELDS CAN BE MAINTAINED. IN PRE-PLANNED DEVELOPMENTS, WHERE SITES FOR INDIVIDUAL WATER SUPPLIES AND ON-SITE SEWAGE MANAGEMENT SYSTEMS ARE PRE-LOCATED SO AS TO MAINTAIN THE 100 FEET SEPARATION DISTANCE, ABSORPTION FIELDS MAY BE INSTALLED LESS THAN 50 FEET, BUT NOT LESS THAN FIVE FEET FROM PROPERTY LINES. NO PART OF THE ABSORPTION FIELD OTHER THAN SOLID SCHEDULE 40 PVC OR EQUIVALENT PIPE WITH WATERTIGHT JOINTS SHALL BE COVERED BY BUILDINGS, PAVEMENTS, OR USED FOR PARKING AUTOMOTIVE VEHICLES OR VEHICULAR TRAFFIC. THERE SHALL BE AVAILABLE SUFFICIENT UNOBSTRUCTED LAND AREA, MEETING ALL REQUIREMENTS FOR THE INSTALLATION OF AN ON-SITE SEWAGE MANAGEMENT SYSTEM, TO PROVIDE FOR THE COMPLETE REPLACEMENT OF THE ABSORPTION FIELD. IF TOPOGRAPHICAL FEATURES PERMIT, THIS REQUIREMENT CAN BE MET BY INSTALLING THE INITIAL ABSORPTION TRENCHES ON 16 FEET CENTERS, THUS ALLOWING FOR REPLACEMENT BETWEEN THE ORIGINAL TRENCHES.

SEPTIC TANKS, AEROBIC TREATMENT UNITS AND ABSORPTION FIELDS ARE PROHIBITED WITHIN 150 FEET OF ANY PERENNIAL STREAM BANK IN A LARGE WATER SUPPLY WATERSHED TRIBUTARY THAT IS UPSTREAM TO A WATER SUPPLY RESERVOIR OF A GOVERNMENTALLY OWNED PUBLIC DRINKING WATER SUPPLY INTAKE AND WITHIN A SEVEN MILE RADIUS OF THE RESERVOIR BOUNDARY AS REQUIRED BY RULES OF THE GEORGIA DEPARTMENT OF NATURAL RESOURCES, ENVIRONMENTAL PROTECTION DIVISION, CHAPTER 391-3-16-.01-CRITERIA FOR WATER SUPPLY WATERSHEDS (HEREAFTER CHAPTER 391-3-16-.01). IN A SMALL WATER SUPPLY WATERSHED: SEPTIC TANKS, AEROBIC TREATMENT UNITS AND ABSORPTION FIELDS ARE PROHIBITED WITHIN 150 FEET OF ANY PERENNIAL STREAM BANK UPSTREAM OF A SMALL WATER SUPPLY RESERVOIR OF A GOVERNMENTALLY OWNED PUBLIC DRINKING WATER SUPPLY INTAKE WITHIN A SEVEN MILE RADIUS OF THE INTAKE OR WATER SUPPLY RESERVOIR; ADDITIONALLY THESE ARE FURTHER PROHIBITED WITHIN 75 FEET OF ANY PERENNIAL STREAM BANK UPSTREAM AND OUTSIDE THE SEVEN MILE RADIUS WITHIN THE SMALL WATER SUPPLY WATERSHED AS REQUIRED BY CHAPTER 391-3-16-.01.

ABSORPTION FIELDS MAY NOT BE INSTALLED IN THE 100 FEET BUFFER AREA OF RIVERS CLASSIFIED FOR PROTECTION UNDER THE RULES OF THE DEPARTMENT OF NATURAL RESOURCES, ENVIRONMENTAL PROTECTION DIVISION, CHAPTER 391-3-16-.04 CRITERIA FOR RIVER CORRIDOR PROTECTION.

#### MINIMUM DESIGN AND CONSTRUCTION CRITERIA:

- ABSORPTION LINES AND ABSORPTION TRENCH BOTTOMS SHALL BE TRUE TO GRADE
- TRENCH BOTTOM DEPTH SHALL BE BASED ON SOIL CONDITIONS AS DETERMINED BY CRITERIA IN THIS MANUAL
- C. A MINIMUM OF SIX TO TWELVE INCHES OF EARTH COVER IS REQUIRED OVER ABSORPTION LINES.
- ABSORPTION LINE LATERALS SHALL BE SPACED A MINIMUM OF SEVEN FEET APART, CENTER TO CENTER.
- ABSORPTION TRENCHES SHALL BE NO MORE THAN 36 INCHES WIDE. THE MINIMUM DEPTH OF AGGREGATE SHALL BE TWELVE INCHES WITH SIX INCHES BELOW THE PERFORATED PIPE AND FILLED TO TWO INCHES ABOVE THE PIPE.
- PERFORATED PIPE SHALL BE LAID IN THE CENTER OF THE TRENCH WITH THE PERFORATIONS ORIENTED TOWARD THE BOTTOM OF THE TRENCH.
- H. A LAYER OF PERVIOUS BUILDING PAPER. STRAW OR SIMILAR PERMEABLE MATERIAL APPROVED BY THE TECHNICAL REVIEW COMMITTEE SHALL BE PLACED OVER THE AGGREGATE BEFORE BACK FILLING.
- APPROVED SOLID PIPE AND FITTINGS WITH SEALED, WATERTIGHT JOINTS SHALL BE USED FOR HORIZONTAL AND VERTICAL CHANGES IN DIRECTION OR GRADE AND TO CROSS UNDER ROADWAYS OR PAVED AREAS. SECTIONS OF SOLID PIPE SHALL NOT BE CONSIDERED IN DETERMINING THE TOTAL ABSORPTION TRENCH BOTTOM AREA.
- EXCAVATION FOR ABSORPTION TRENCHES IN SOILS OTHER THAN SANDS SHALL NOT BE CONDUCTED WHEN WET DUE TO THE POTENTIAL IRREVERSIBLE DAMAGE TO SOIL STRUCTURE, SUCH AS COMPACTION AND SMEARING.
- PVC FORCEMAIN FROM PUMP TANK TO DISTRIBUTION BOX SHALL BE AWWA C900, DR 25 (100 PSI). FORCEMAIN SHALL HAVE 3' MINIMUM COVER UNDER DRIVEWAY.

#### **DISTRIBUTION BOX METHOD:**

ON LEVEL OR SLOPING TOPOGRAPHY, THE DISTRIBUTION BOX METHOD MAY BE USED AND SHALL BE REQUIRED WHEN DOSING TANKS ARE USED. A FIRM EARTHEN FOUNDATION SECURED BY CONCRETE OR CONCRETE FOUNDATION FOR DISTRIBUTION BOXES EXTENDING AT LEAST 12 INCHES BEYOND THE WALLS OF THE BOX SHALL BE PROVIDED TO INSURE AGAINST TILTING OF THE DISTRIBUTION BOX. INSTALLATION OF THE DISTRIBUTION BOX SHALL BE MADE TO PROVIDE EQUAL FLOW TO EACH ABSORPTION LINE EXTENDING FROM THE BOX. THE TOP OF THE DISTRIBUTION BOX SHALL HAVE A MINIMUM EARTH COVER OF SIX INCHES, BUT NO MORE THAN TWELVE INCHES UNLESS PROVISIONS ARE MADE FOR EASY ACCESS TO THE DISTRIBUTION BOX. THE SEWER FROM THE SEPTIC TANK, AEROBIC TREATMENT UNIT OR DOSING TANK SHALL ENTER THE DISTRIBUTION BOX AND TERMINATE INSIDE THE DISTRIBUTION BOX WITH AN ELBOW TURNED DOWNWARD TO FORM A SUBMERGED OUTLET AT NORMAL WATER LEVEL TO MINIMIZE TURBULENCE. ALTERNATELY, A BAFFLE MAY BE USED IF THE SAME FUNCTION IS ACCOMPLISHED. ABSORPTION LINES OF EQUAL LENGTH SHALL BE CONNECTED TO THE DISTRIBUTION BOX OUTLETS BY WATERTIGHT INDEPENDENT SEWERS CONSISTING OF FOUR-INCH SCHEDULE 40 PVC PIPE OR EQUIVALENT. ALL INDEPENDENT SEWER LINES SHALL BE INSTALLED LEVEL AT THE SAME ELEVATION FOR TWO FEET. BEGINNING TWO FEET FROM THE DISTRIBUTION BOX TO THE BEGINNING OF THE ABSORPTION LINE, INDEPENDENT SEWER LINES SHALL BE INSTALLED TO PROVIDE A MINIMUM DOWNWARD GRADE CHANGE OF TWO INCHES FROM THE DISTRIBUTION BOX OUTLET TO THE PERFORATED PIPE AT THE BEGINNING OF THE ABSORPTION LINE. ABSORPTION LINES SHALL BE INSTALLED LEVEL OR ON A UNIFORM GRADE OF NO MORE THAN FOUR INCHES OF FALL FOR THE ENTIRE LENGTH OF THE INDIVIDUAL ABSORPTION LINE. ABSORPTION LINES FROM DISTRIBUTION BOXES USED IN CONJUNCTION WITH DOSING TANKS SHALL NOT EXCEED 125 FEET IN

- 1. THE CONTRACTOR SHALL PROVIDE THREE WORKING DAYS NOTICE TO THE UTILITIES PROTECTION CENTER BY CALLING 811 IN ORDER TO LOCATE UTILITIES PRIOR TO STARTING ANY EXCAVATION OR CONSTRUCTION.
- THE LOCATIONS OF UNDERGROUND UTILITIES AS SHOWN HEREON ARE BASED ON ABOVE-GROUND STRUCTURES PROVIDED BY THE SURVEYOR. NO EXCAVATIONS OR SUBSURFACE LOCATING SERVICES WERE MADE DURING THE PERFORMANCE OF THE TOPOGRAPHIC SURVEY TO LOCATE / IDENTIFY BURIED UTILITIES / STRUCTURES. LOCATIONS OF UNDERGROUND UTILITIES / STRUCTURES MAY VARY FROM LOCATIONS SHOWN HEREON.
- 3. CONTRACTOR SHALL BE RESPONSIBLE FOR REPAIRING ANY UTILITIES DAMAGED DURING DEMOLITION AND/OR CONSTRUCTION AT NO ADDITIONAL COST TO THE OWNER.
- THE CONTRACTOR SHALL VERIFY ALL DIMENSIONS AND EXISTING CONDITIONS PRIOR TO STARTING WORK AND SHALL BE RESPONSIBLE FOR THE PROPER FIT OF ALL COMPONENTS. SOME DIMENSIONS AND CONDITIONS MAY VARY. NOTIFY ENGINEER IN WRITING OF ANY DISCREPANCIES OR CONFLICTS.
- CONTRACTOR SHALL COORDINATE WITH APPROPRIATE UTILITY COMPANIES TO SCHEDULE ALL UTILITY & SERVICE INTERRUPTIONS TO OCCUPIED PORTIONS OF THE SITE.
- 6. A 10 FOOT HORIZONTAL AND 18 INCH VERTICAL CLEARANCE SHALL BE MAINTAINED BETWEEN SANITARY SEWER LINES AND ANY WATER OR STORM LINES. WATER AND STORM LINES SHALL BE ABOVE ANY SANITARY LINES.
- MAINTAIN A MINIMUM OF 4' OF COVER ABOVE WATER MAINS.
- 8. ALL SANITARY SEWER LINES SHALL HAVE A MINIMUM OF 1% SLOPE UNLESS OTHERWISE NOTED.
- 9. FOR ANY WORK IN DOT RIGHT-OF-WAY, AN ENCROACHMENT AND/OR UTILITY PERMIT MAY BE REQUIRED.
- 10. ALL METERS, VALVES, AND BACKFLOW PREVENTORS ARE TO BE IN COMPLIANCE WITH THE LOCAL UTILITY AUTHORITY'S REQUIREMENTS.
- 11. ADJUST ALL TOP OF STRUCTURE ELEVATIONS (MANHOLES, CLEANOUTS, VALVE BOXES, ETC.) TO FINISHED GRADE ELEVATIONS.
- 12. ALL SANITARY SEWER WORK SHALL BE IN ACCORDANCE WITH THE LOCAL UTILITY AUTHORITY'S STANDARDS AND SPECIFICATIONS.
- 13. AT THE END OF EACH DAY'S WORK, REMOVE ANY DEBRIS, MATERIAL, ETC. (RESULTING FROM CONTRACTOR'S UTILITY OPERATIONS) THAT IS NOT WITHIN THE CONTRACTOR CONSTRUCTION LIMITS.
- 14. ALL PROPOSED AND EXISTING PAVEMENT AND CURB TO REMAIN SHALL BE PROTECTED. IF DAMAGED, IT SHALL BE REPLACED PROMPTLY TO MEET STATE AND LOCAL REQUIREMENTS AT THE CONTRACTOR'S EXPENSE.
- 15. CONTRACTOR IS REQUIRED TO NOTIFY ENGINEER IN WRITING OF ANY DISCREPANCIES OR CONFLICTS ENCOUNTERED DURING CONSTRUCTION ACTIVITIES.

ON-SITE SEWAGE MANAGEMENT SYSTEM NOTES:

AN ON-SITE SEWAGE MANAGEMENT / PERMIT MUST BE OBTAINED FROM THE CHATHAM COUNTY ENVIRONMENTAL HEALTH DEPARTMENT

#### SEPTIC TANK/ATU SHOULD BE LOCATED WITH THE FOLLOWING GUIDELINES: . NO LESS THAN 50' FROM EXISTING OR PROPOSED WELL/SPRINGS, SINK HOLES

- OR SUCTION LINES 2. NO LESS THAN 25' FROM GEOTHERMAL BORE HOLES, LAKES, PONDS, STREAMS,
- WATER COURSES, AND OTHER IMPOUNDMENTS 3. NO LESS THAN 10' FROM PRESSURE WATER SUPPLY LINES.
- NO LESS THAN 10' FROM PROPERTY LINES.
- NO LESS THAN 15' FROM A DRAINAGE DITCH OR EMBANKMENT.
- 6. NO LESS THAN 10' FROM HARDSCAPES, DRIVES, SWIMMING POOLS, AND BUILDING FOUNDATIONS
- ABSORPTION FIELDS SHOULD BE LOCATED WITH THE FOLLOWING GUILDELINES . NO LESS THAN 100' FROM EXISTING OR PROPOSED WELLS, SPRINGS, OR SINKHOLES
- 2. NO LESS THAN 10' FROM WATER SUPPLY LINES AND BUILDINGS WITH BASEMENTS NO LESS THAN 5' FROM BUILDINGS WITHOUT BASEMENTS, OTHER STRUCTURES, DRIVES, AND PROPERTY LINES
- 4. NO LESS THAN 15' FROM AN EMBANKMENT, SWIMMING POOL FOUNDATION,
- DRAINAGE DITCH OR TRASH PITS
- 5. NO LESS THAN 50' FROM GEOTHERMAL BORE HOLES AND THE NORMAL WATER LEVEL OF ANY IMPOUNDMENT, TRIBUTARY, STREAM, OR OTHER BODY OF WATER, INCLUDING PONDED AREAS OF WETLANDS.

#### PRIMARY & SECONDARY SEPTIC DRAIN FIELD SIZING CALCULATIONS: PROPOSED INDUSTRIAL SHOP

PROPOSED USE: INDUSTRIAL/SHOP SANITARY SEWER FLOW RATE = 30 GPD/PERSON EMPLOYEES = 20 PERSONS

#### TOTAL FLOW = 600 GPD

PERCOLATION COEFFICIENT CALCULATIONS FOR NON-RESIDENTIAL FACILITIES (TABLE 9.F FROM OSSM) PERCOLATION RATE (T): 30 MINUTES PER INCH


REQUIRED SF OF DRAIN FIELD: (GALLONS PER DAY / PERCOLATION COEFF.) 600 GPD / 0.913 GPD/SF = 657.17 SF

657.17 SF / 3 FT (TRENCH BOTTOM WIDTH) = 219 LF OF CONVENTIONAL DRAIN FIELD

REDUCTION FOR USING (ADS SEPTIC STACK SS-13-36) = 33% TOTAL REQUIRED LINEAR FEET OF SYSTEM AFTER REDUCTION = 147 LF

PERCOLATION COEFFICIENT (5 / SQ ROOT T): 0.913 GPD / SF

TOTAL PROVIDED LINEAR FEET OF SYSTEM = 148 LF

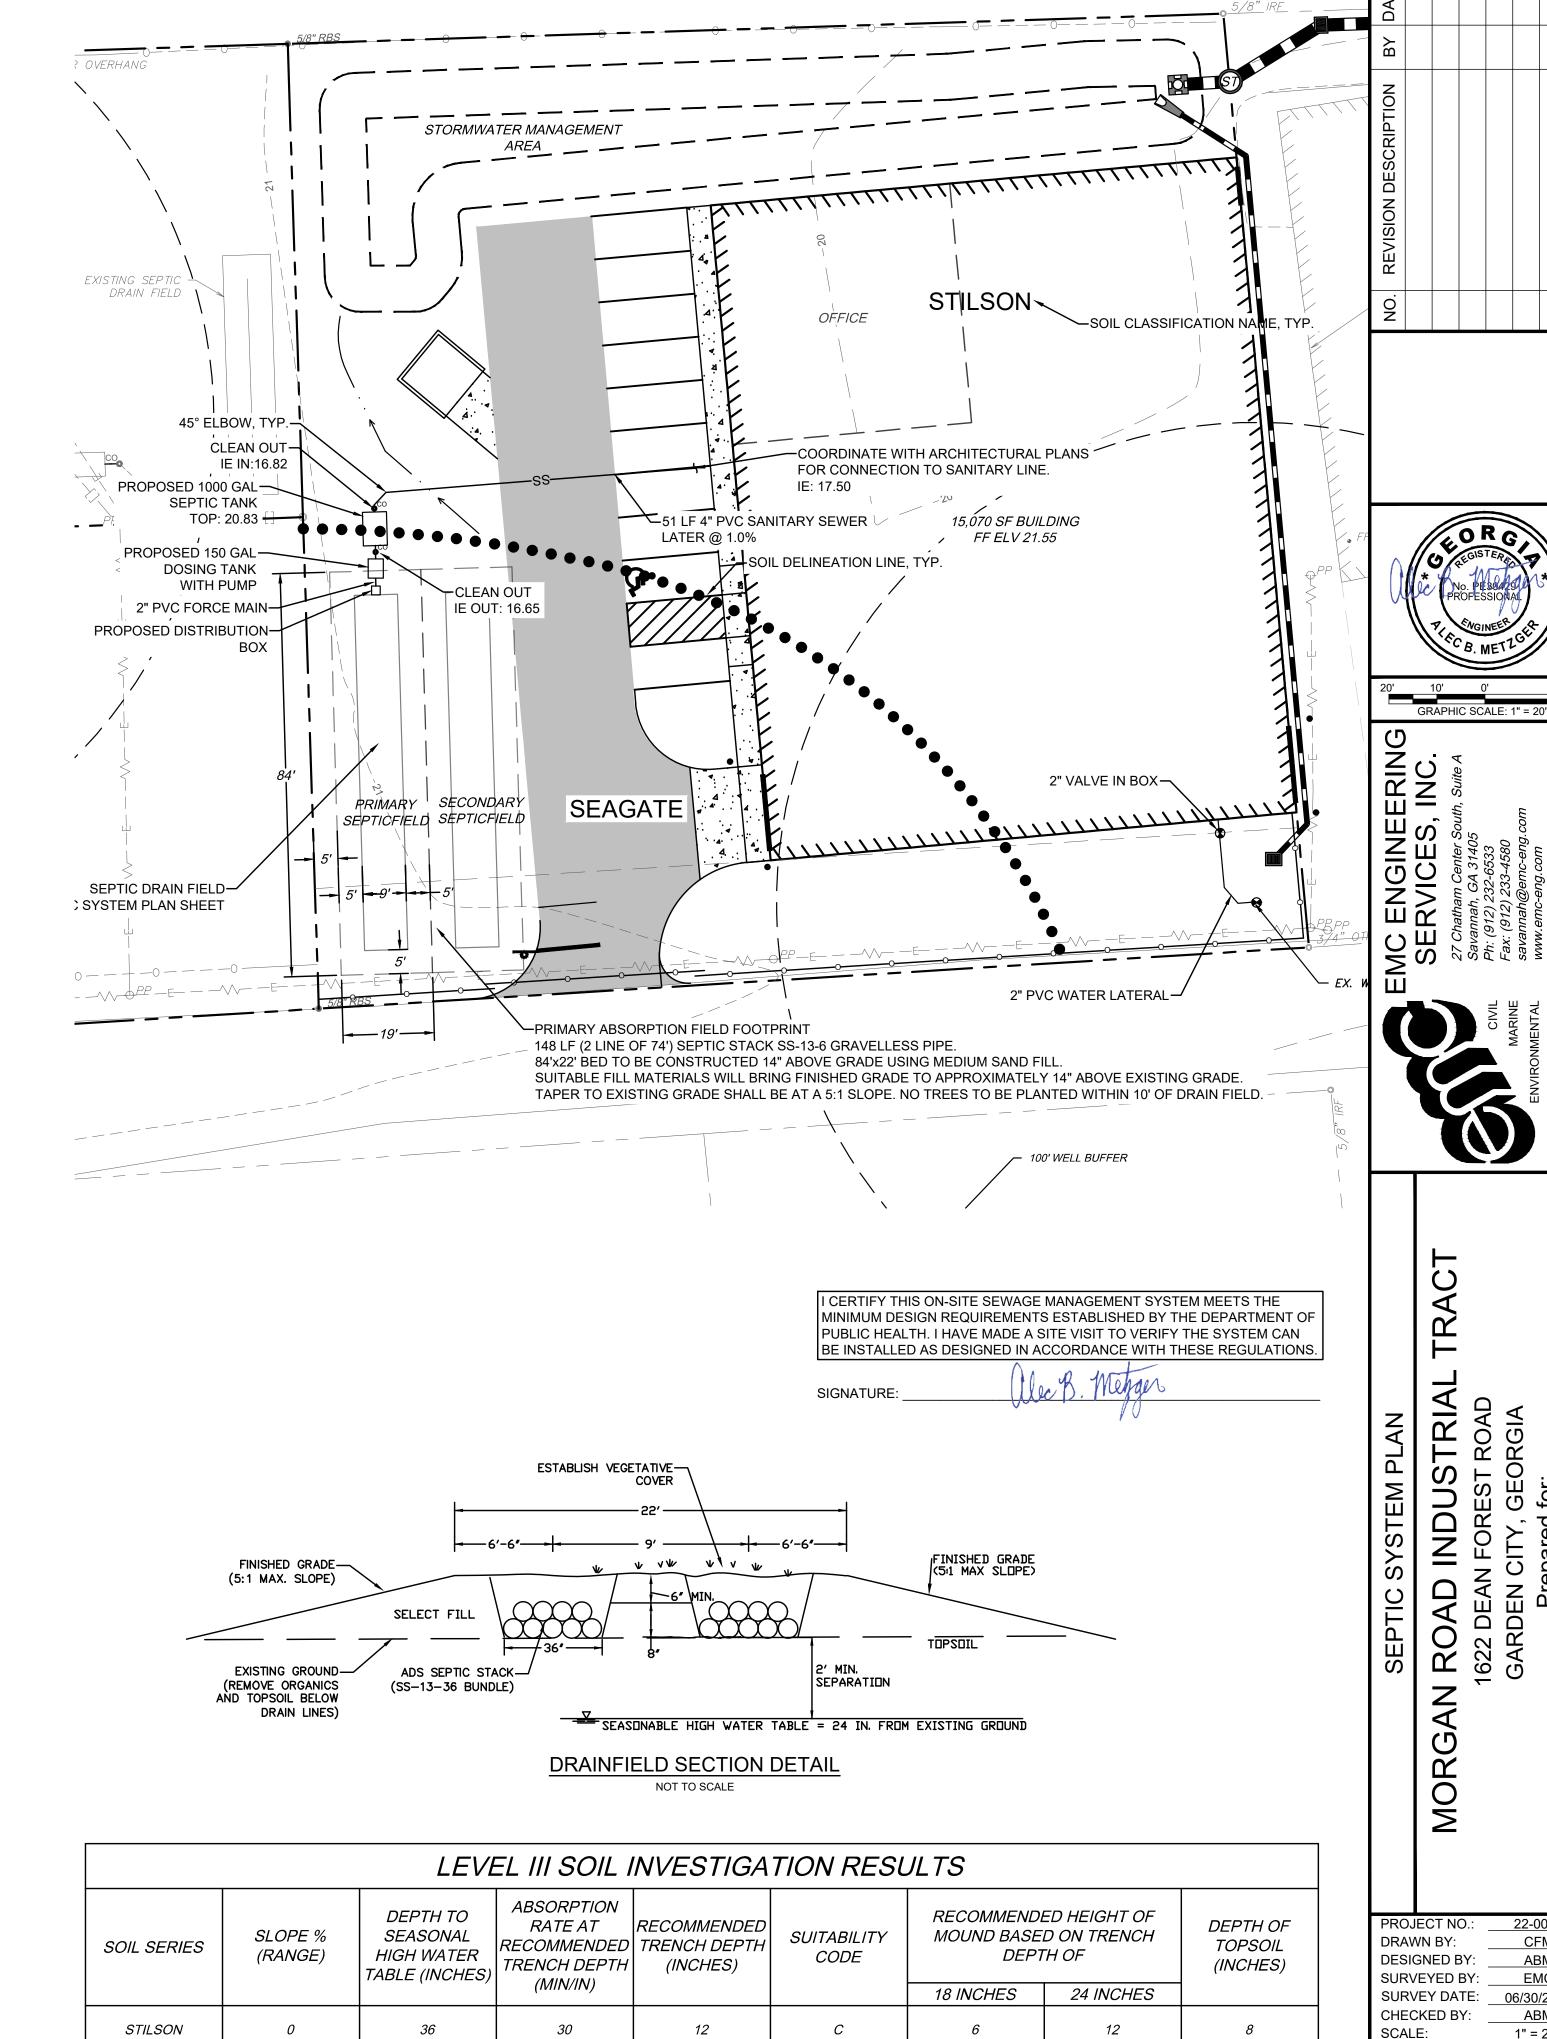

\* SEE SOIL SURVEY PROVIDED BY DONNIE BRADSHAW

30

SEAGATE

1" = 20' FEB., 2023 SHEET

DATE:

24

4 - 8

22-0039


CFM


EMC


06/30/2022

ABM

ABM

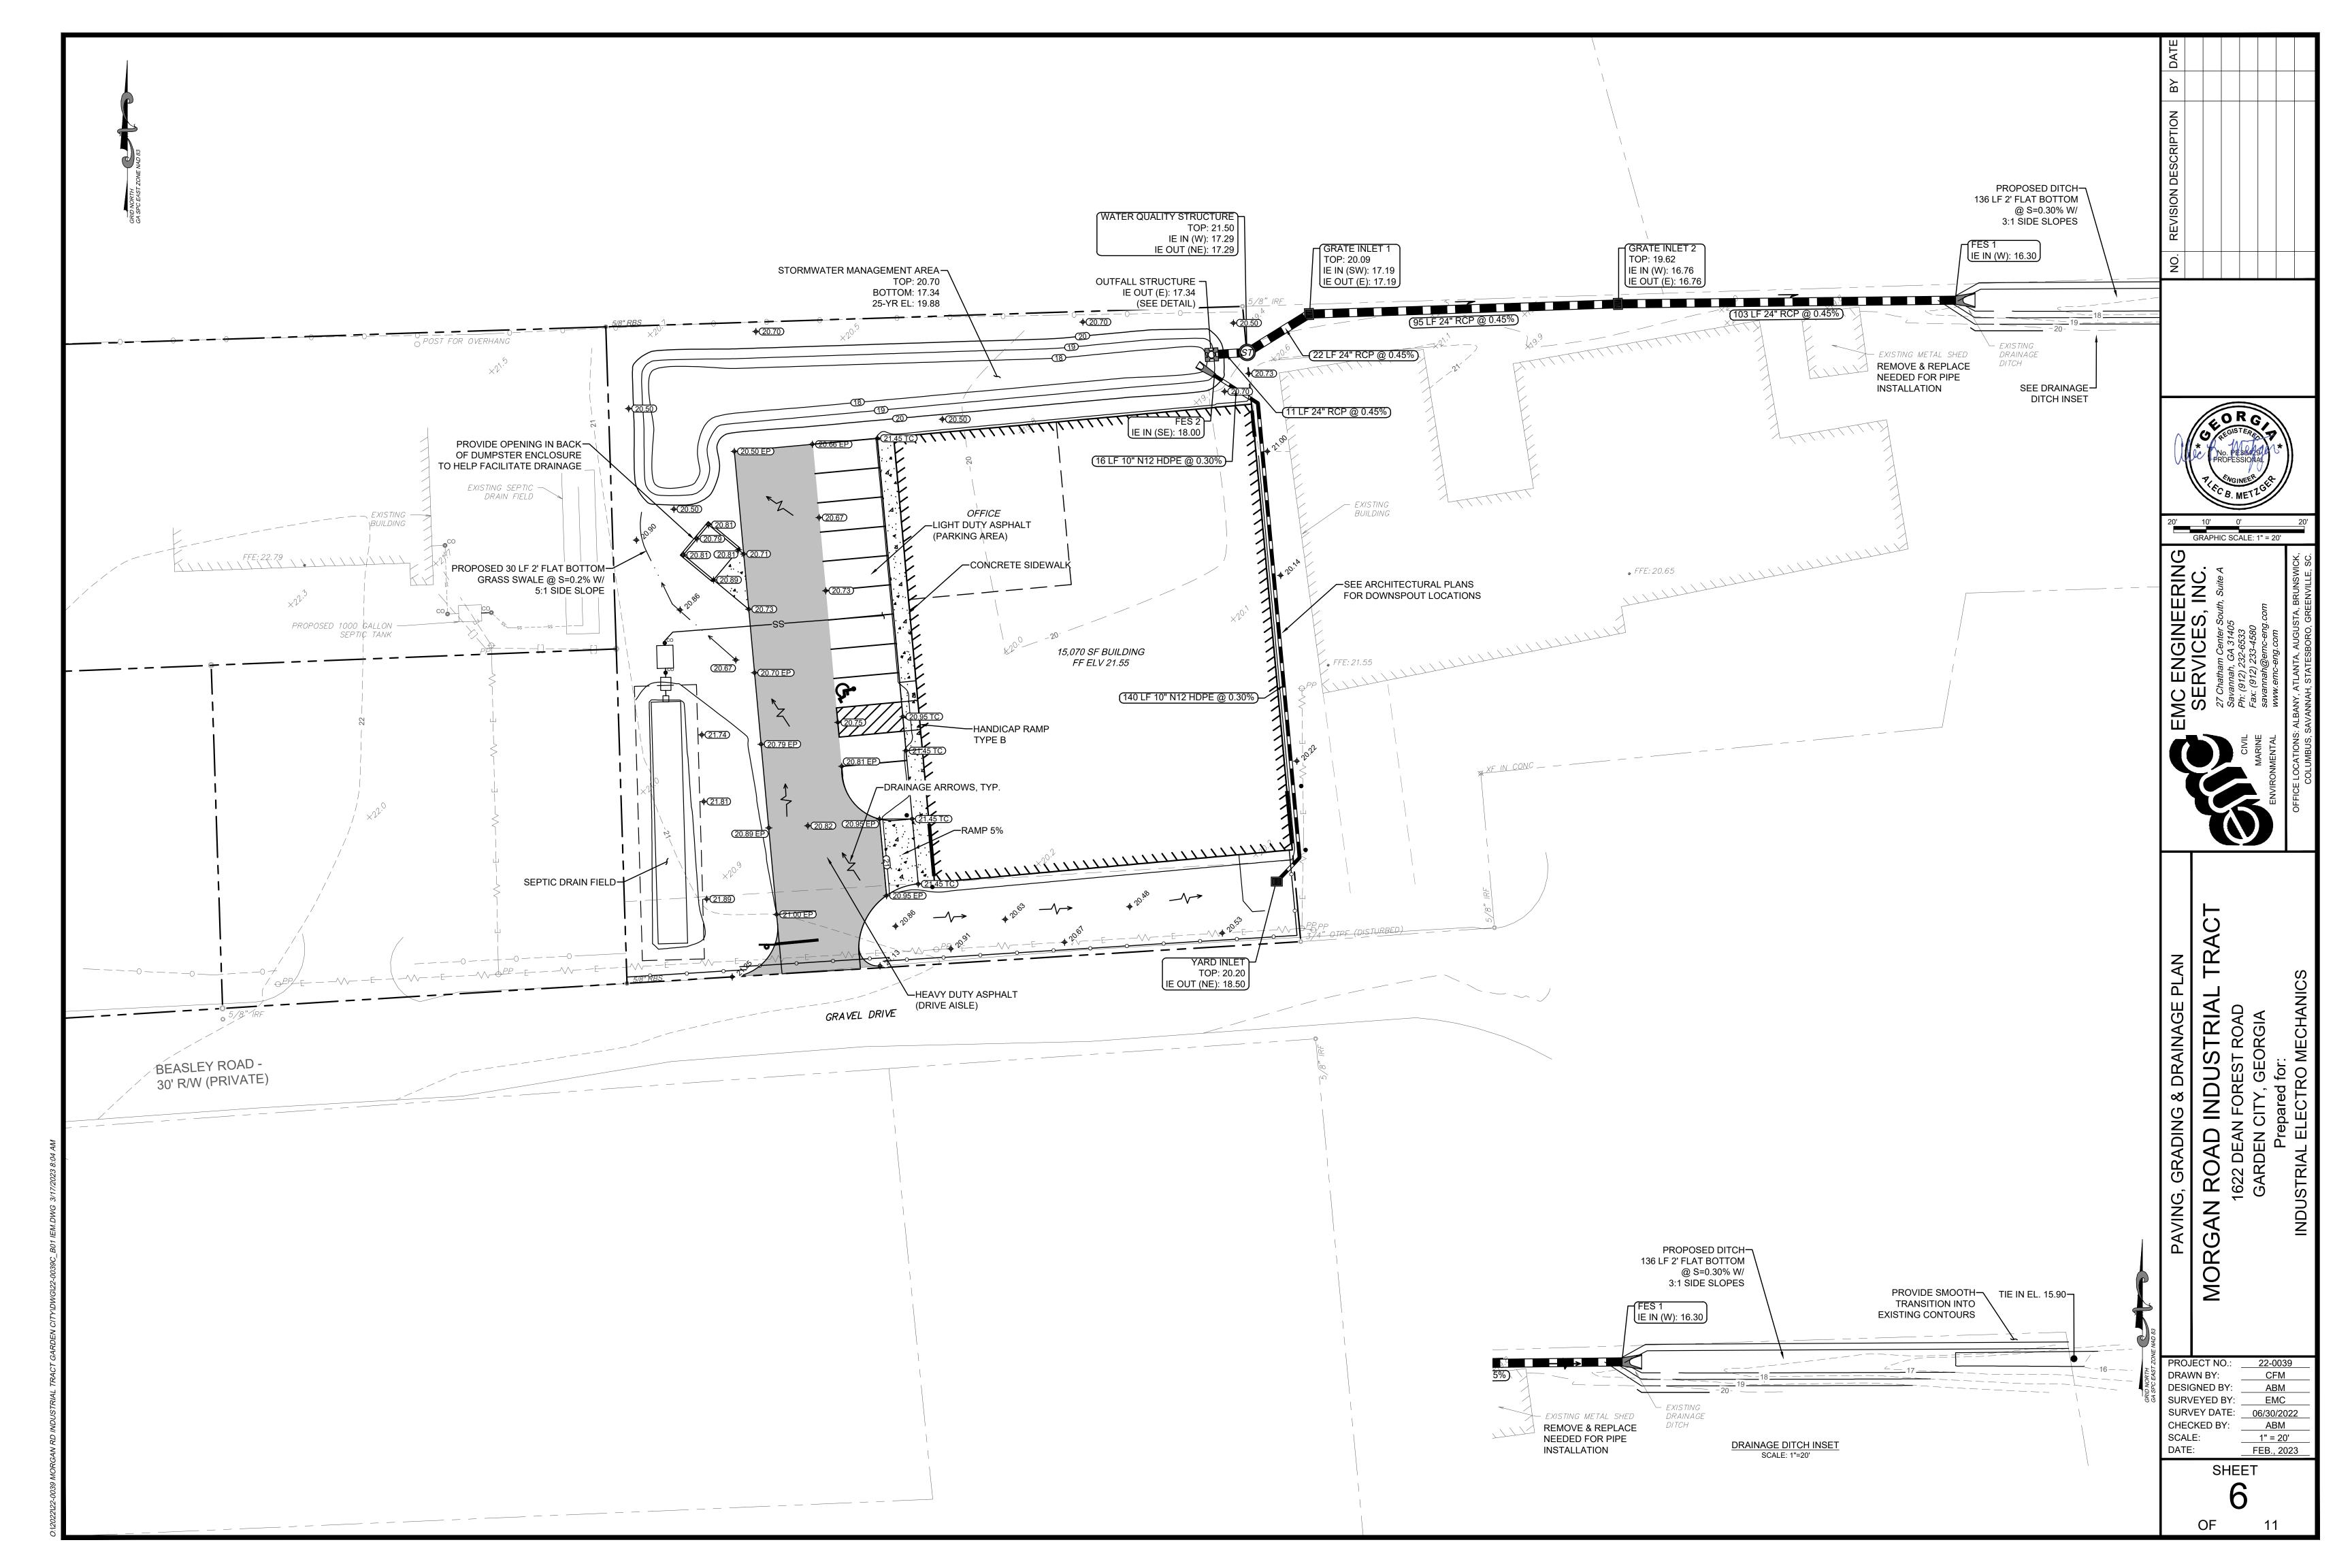

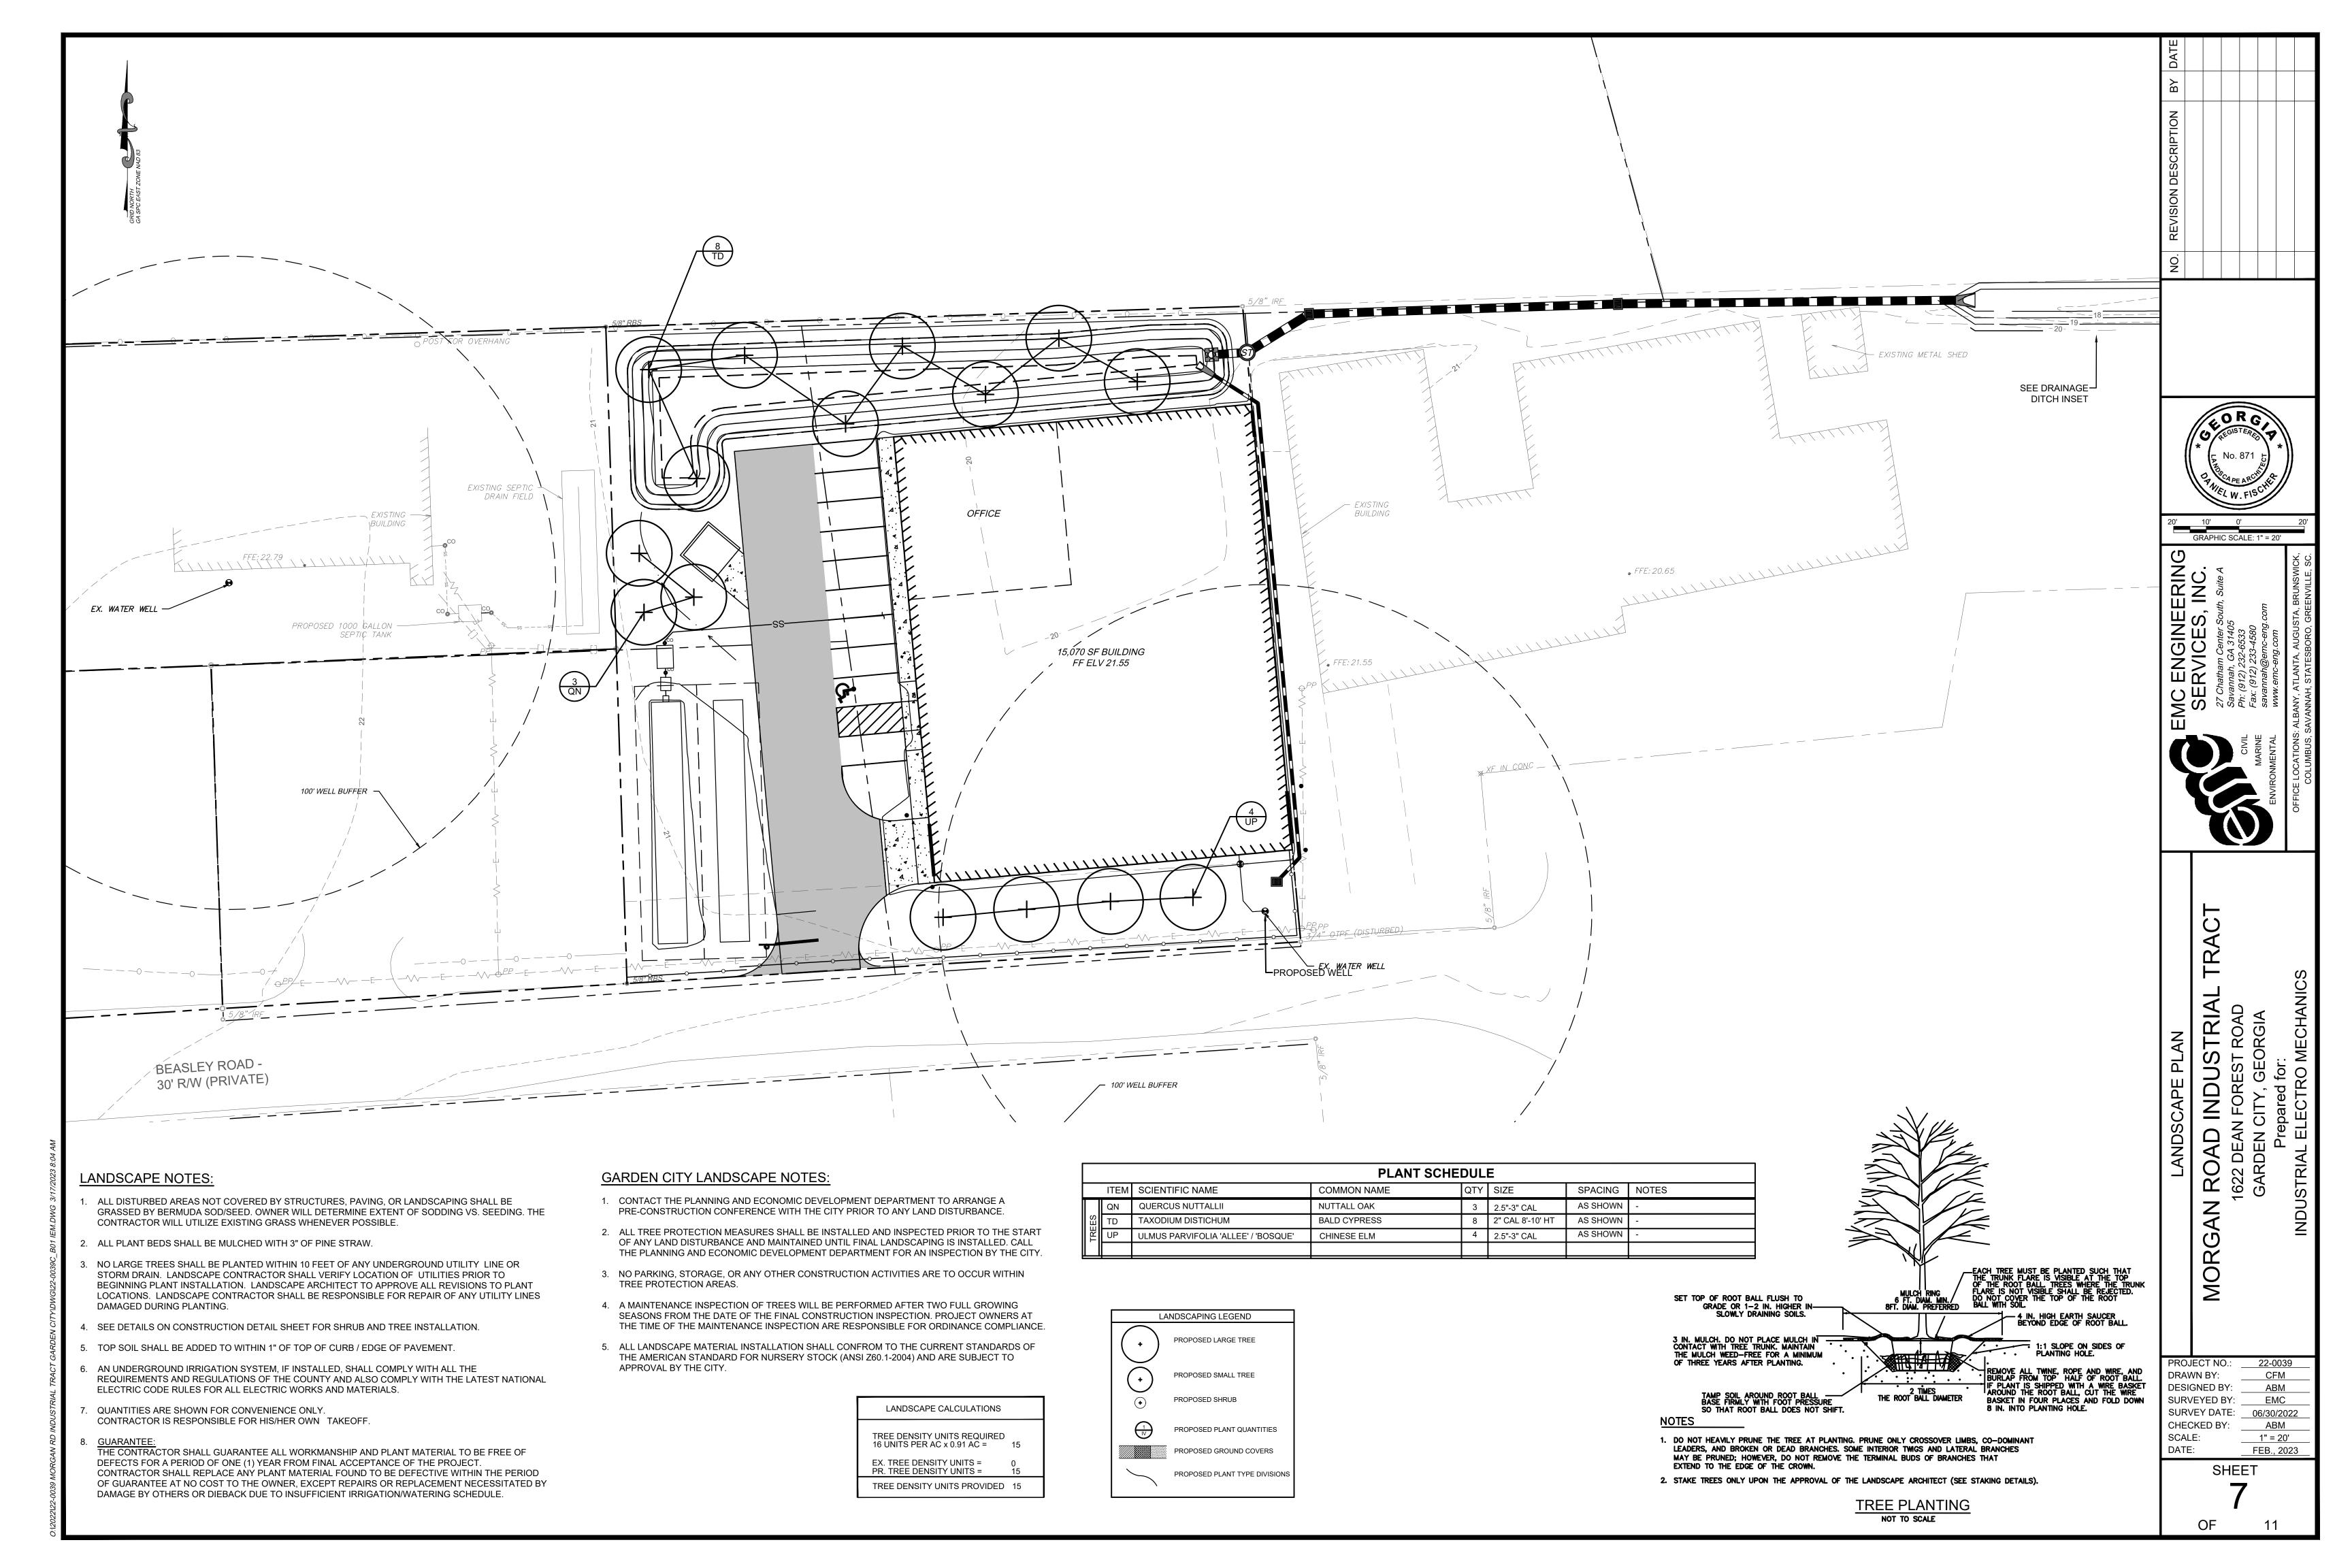

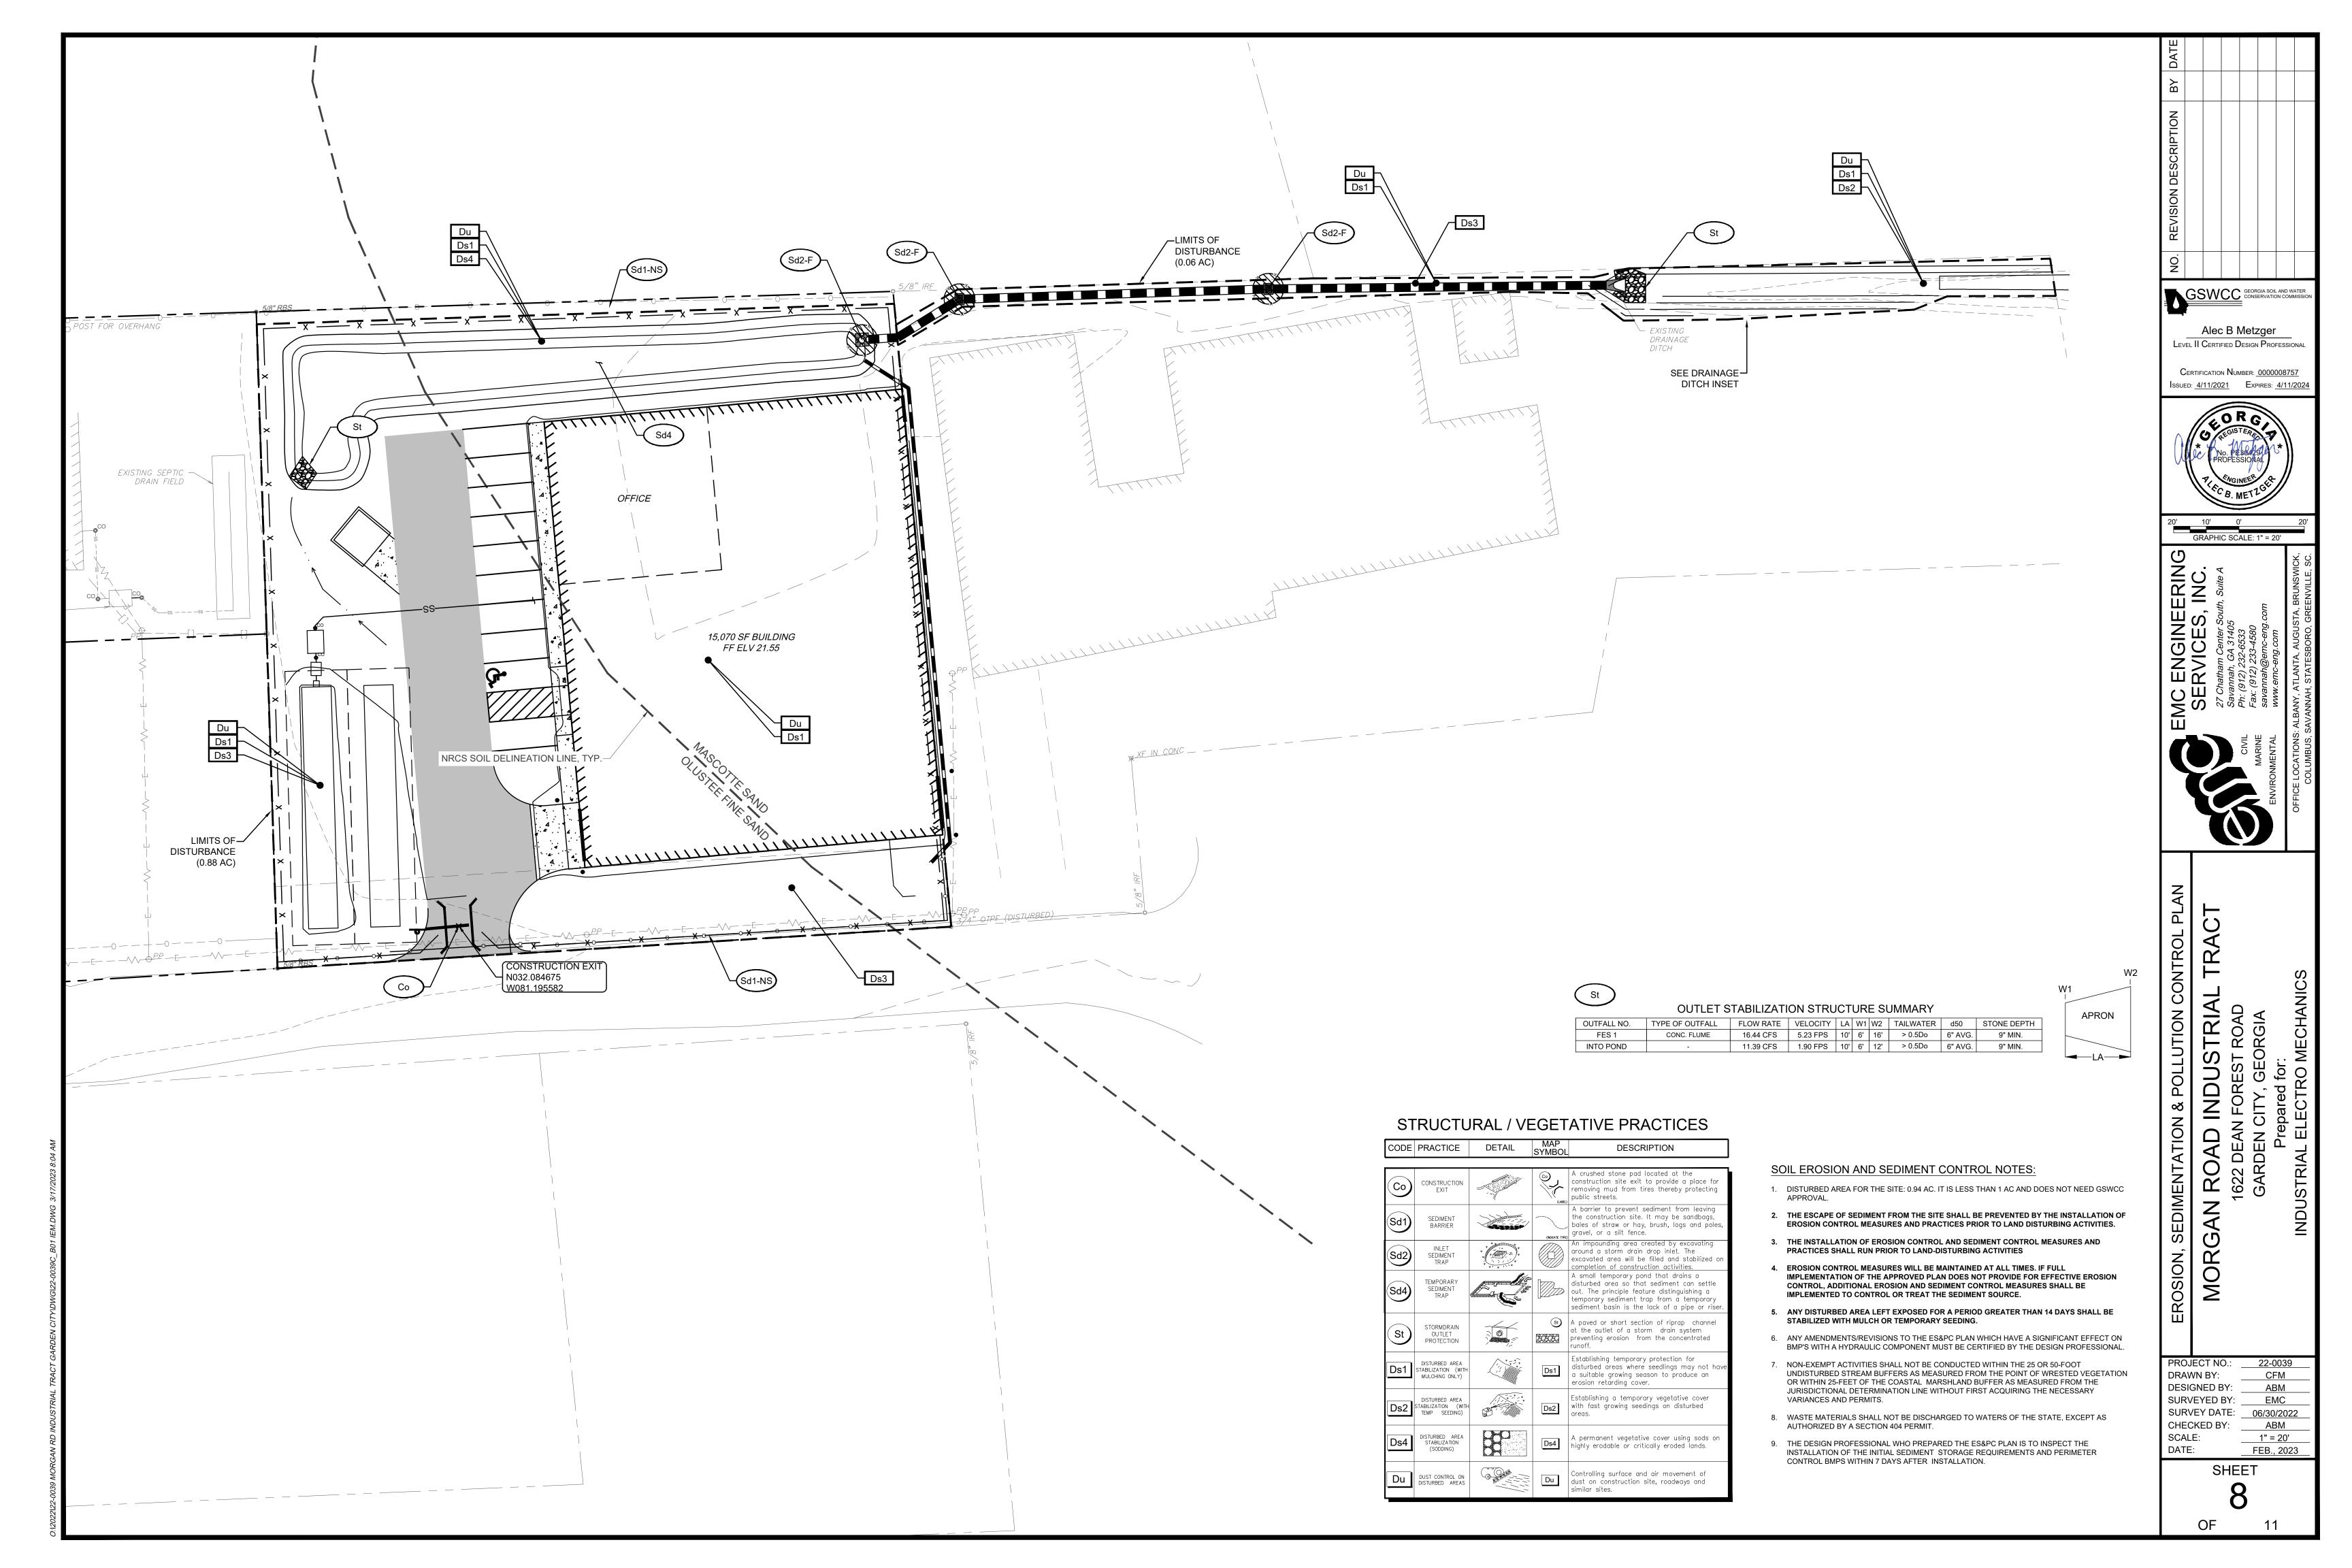



#### INLAND BUILDINGS

2141 SECOND AVENUE S.W. CULLMAN, ALABAMA 35055

PHONE: 800-438-1606 FAX: 800-438-1626 www.inlandbuildings.com

#### BUILDING DESCRIPTION

D D	138.00' x 30.00' SLOPE: 1.0:12 SLOPE:
BUILDING SIZE:	SLOPE:
BUILDING SIZE:	SLOPE:
(BUILDING DIMENSIONS ARE	NOMINAL, REFER TO PLANS)
code shown below. The certification is limited to the by the building manufacturer and is specified in the translucent panels, and ventilators are not included building manufacturer such as foundations, masonry	zing the loads indicated and applied as required by the building e structural design of the framing and covering parts manufactur contract. Accessory Items such as doors, window, louvers, Also excluded are other parts of the project not provided by the walls, mechanical equipment and erection of the building. The undation in accordance with the building manufacturer's design actices.
General Loads	
Roof Dead Load (D)	2.500 psf
Roof Collateral Load (C)	3 psf
Roof Live Load (Lr)	20.00 psf
Tributary Live Load Reduction	Yes
Snow Load	
Flat-Roof Snow Load (Pf)	0.0000 psf
Ground Snow Load (Pg)	0.0000 psf
Snow Exposure Factor (Ce)	<u> </u>
Snow Load Importance Factor (Is)	1.0000
Thermal Factor (Ct)	1.00
Wind Load	
Wind Speed (V 3S)	133.0000 <b>GDN1</b>
Wind Speed (Vult & Vasd)	N/A mph N/A mph GDN2
Occupancy / Risk Category	I <u>Normal</u>
Wind Exposure Category	C CDN4
Internal Pressure Coefficient (GCpi)	+/- 0.18 Closed CDN5
Wind Enclosure Wind Importance Factor	1.0000 GDN7
•	GDN8
Seismic Load	1.00 <b>GD</b> N9
Seismic Importance Factor (Ie) Spectral Response Accelerations (Ss and S1)	0.3012 0.1110
Site Class	d 0.1110
Spectral Response Coeffecients (Sds and Sd1)	0.3129 0.1760
Seismic Design Category	<u>C</u>
Basic Seismic-Force-Résisting System(s) *	
	Longitudinal Lateral
Total Design Base Shear (V)	13.48 Kips 43.06 Kips
Seismic Response Coefficient(s) (Cs)	0.1043 0.1043
Response Modification Factor(s) (R)	3.0000 3.0000
Analysis Procedure: Equivalent Lateral Force	


Analysis Procedure: Equivalent Lateral Force	
* Ordinary Steel Concentrically Braced Frame(s) and/or Ordinary Steel Moment Frame	(s)

DANIEL TRUL AND EDAMING INCORPATION			
PANEL, TRIM AND FRAMING INFORMATION ROOF PANELS	<u>IRIM</u>		
TYPE:         TS-324 GAUGE:         24 COLOR:         Galvalume           UL90 CERTIFICATION:         No	EAVE: GUTTER: DOWNSF	OUT:	COLOR: Need Std. Color
WALL PANELS  TYPE: PBR GAUGE: 26 COLOR: Need Std. (INSULATION: 6 In	BASE TO CORNER LINER:	RIM:	COLOR: Need Std. Colo COLOR: Need Std. Colo COLOR: COLOR:
LINER PANELS TYPE: GAUGE: COLOR: HEIGHT: <u>FULL</u>	CAP TR	SILL:	COLOR:
FASCIA PANELS TYPE: GAUGE: COLOR: SOFFIT PANELS	(MAIN F	RY FRAMING FRAMES & ENDWALL FRAME COLUMNS & BENTS)	S) <u>Red-Oxide</u>
TYPE:         GAUGE:         COLOR:            PARTITION PANELS         COLOR:	(GIRTS,	NDARY FRAMING EAVE STRUTS, PURLINS TRAMED OPNG. & CLIPS ETC	Red-Oxide
TYPE: COLOR:			

	DRA	WING INDEX
ISSUE	PAGE	DESCRIPTION
х	C1 OF 1	COVER PAGE
х	A1 OF 2	ANCHOR BOLT PLAN
Х	A2 OF 2	ANCHOR BOLT DETAILS
X	E1 OF 9	ROOF PLAN
Х	E2 OF 9	ROOF SHEETING
Х	E3 0F 9	ROOF BRACING
х	E4 OF 9	CROSS SECTION
X	E5 OF 9	CROSS SECTION
X	E6 OF 9	SIDEWALL FRAMING
X	E7 OF 9	SIDEWALL SHEETING
Х	E8 OF 9	ENDWALL FRAMING
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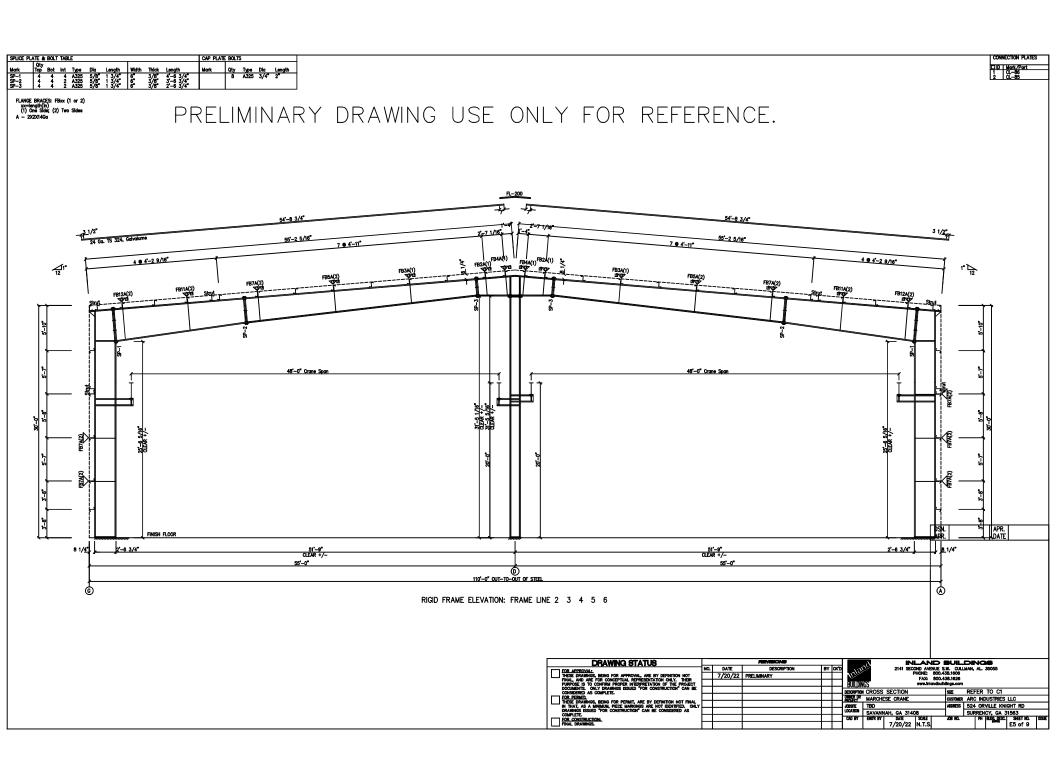
Registration # F-12852

IAS Certification Accredited Certification # MB-205

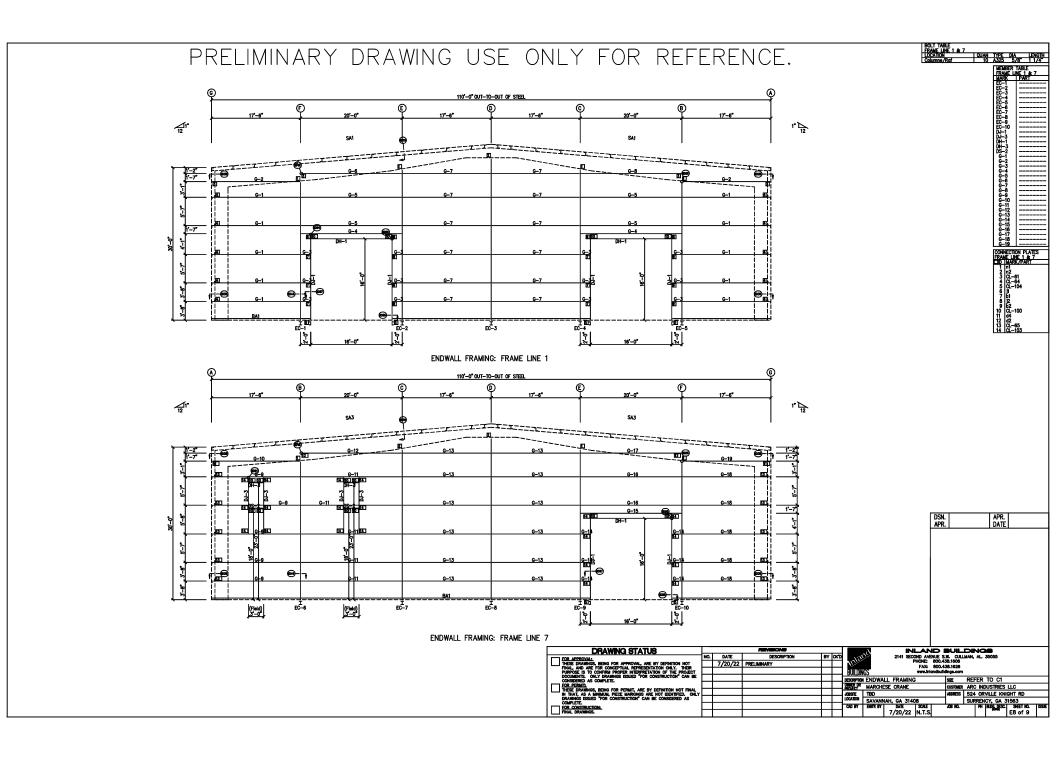


#### PRELIMINARY DRAWING USE ONLY FOR REFERENCE. € စု ⅌ FL-275 : 15'-3", FL-207 : 9'-5" FL-275 ; 15'-3", FL-207 ; 9'-5" FL-275L 11'-2" FL-275R : 11'-2" 16'-7" 16'-4" 16'-7 16"-1" 16'-1" 74 14 14 14 F-28: 16-32 - 32-11" 34'-5" 34'-2" 33-11 33-5 31-2" 31'-5" 31'-2" 30'-11" 31,-5 1-38:16-3 FL-60 : 20'-2" ENDWALL SHEETING & TRIM: FRAME LINE 1 € <u>FL-275 : 15'-3", FL-207 : 9'-5", FL-208 : 18'-7"</u> FL-275: 15'-3", FL-207: 9'-5", FL-208: 18'-7" FL-275L 11'-2" FL-275R : 11'-2" 16'-7" 16'-1" 34.-5 34-5 33'-11" 34.-2 35-2" 35-5" 33.-8 30'-11" 유=38 : 16=5- 3r-Je 30,-5 FL-60 : 20'-2" ENDWALL SHEETING & TRIM: FRAME LINE 7 PANELS: 26 Ga. PBR - Need Std. Color INLAND BUILDINGS 2141 SECOND AVENUE S.W. CULLMAN, AL 35055 PHONE: 600.438.1608 FAX: 800.438.1628 DRAWING STATUS DATE 7/20/22 PRELIMINAR BULLINES BESERPRON ENDWALL SHEETING BESERPRON ENDWALL SHEETING BESERPRON MARCHESE CRANE JOSHE TED LOCATION SAVANNAH, GA 31408 CAD BY BIEF BY DATE SOLE 7/20/22 N.T.S. SIZE REFER TO C1 USTOMER ARC INDUSTRIES LLC ADDRESS 524 ORVILLE KNIGHT RD SURRENCY, GA 31563 AGB NO. PH BLOGGESS SEET NO. E9 of 9 CENERAL NOTES: THE IS FIDERED WITH 2" TIME LAP INNESS NOTED ON A DETAIL THE IS FIDERED WITH 2" TIMED GENERICS, WALKDOORS, AND WINDOWS, FORWARD BACE TIME (F 1920) TO BE FEED MITTERED AT CONNERS. BEVELOUT BOWNLY AWARD AS RECOURD. FIELD SLOT GRITS AS RECOURED FOR CABLE BRACE CLEARANCE.

Qty Type Dia Length 8 A325 5/8" 2" FLANGE BRACES: FBxx (1 or 2) xx=length(in) (1) One Side; (2) Two Sides A - 2X2X14Ga PRELIMINARY DRAWING USE ONLY FOR REFERENCE. 3 1/2" 4 9 4'-2 9/16" 1" 12 48'-0" Crane Span 2'-6 3/4" 8 1/4" 51"-9" CLEAR +/-51'-9" CLEAR +/-RIGID FRAME ELEVATION: FRAME LINE 1 7 INLAND BUILDINGS
2141 SECOND AVENUE S.W. CULLMAN, AL 35055
PHONE: 800.438.1626
FAX: 800.438.1626 DRAWING STATUS 7/20/22 PRELIMINA 





### PC2319: General Development Plan Review

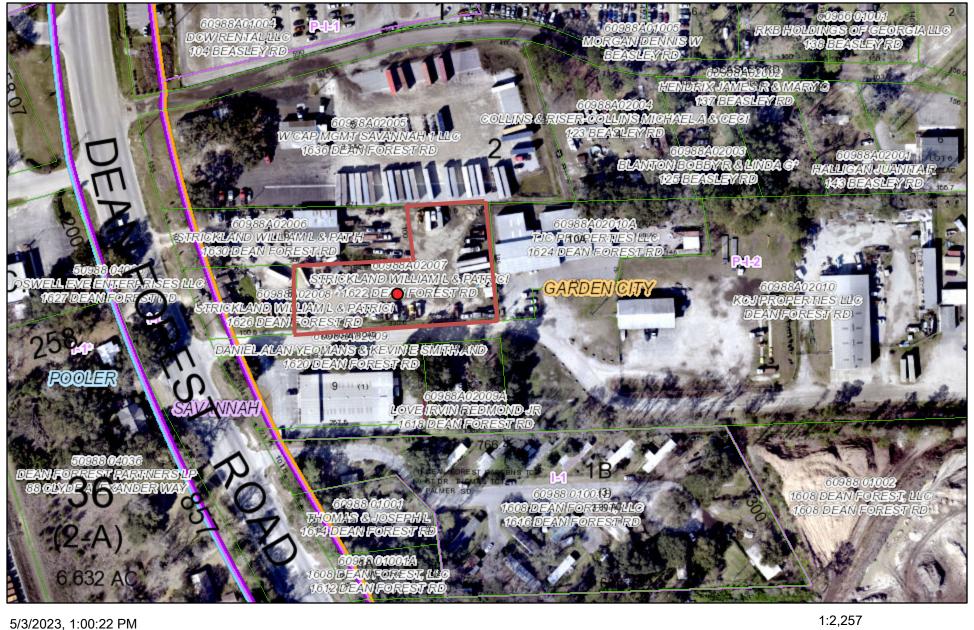

UNINCORPORATED

Owner, PIN and Address Labels

Zoning

Municipal Boundary


POOLER

GARDEN CITY SAVANNAH

BLOOMINGDALE PORT WENTWORTH TYBEE ISLAND

THUNDERBOLT

■ VERNONBURG

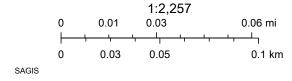

SAGIS |

#### City of Garden Site Plan Application



Development Information  Development Name	1		
•	DUIL DING ADDITION	-	
1620 DEAN FOREST ROAD  Property Address	BUILDING ADDITION		
1620 DEAN FOREST ROAD	)		
GARDEN CITY, GA			
Phased development?		If yes, indicate propo	osed number of phases:
□ Yes ■ No			
Parcel ID	Total Site Acreage		Zoning
60988A 02009	1.051		P-I-2
Project Description			
ADDITION OF A 5,661 SF N	METAL BUILDING ONTO A	N EXISTING	
			NTO
12,221 SF METAL BUILDIN Water Supply	IG AND ASSOCIATED ACT	Sewage Disposal	1115.
□ Public ■ Private		□ Public ■ Privat	9
Trubic Strivate		- Tubile Britis	
Applicant Information  Owner		Address	
Name		Address	
RYAN	HUGHES		P.O. BOX 5982
Phone		Email	
(912)6	662-2750		ryan@corecd.com
Engineer/Surveyor	☐ Same as authorized age		o receive staff review comments via email
Company Name		Contact (Individual N	ame)
Coastal Civ	ril Engineering		Tom Havens
Phone		Email	
(912)	232-9402		havens@coastalcvil.com
Authorized Agent (Requires Auth	orized Agent Form)		o receive staff review comments via email
Company Name		Contact (Individual N	
CONSTAL	CML FNGNEERING		Havens
Phone		Email	
9/2-66	-2399	TOM HAVE	MJ @ COASTAL CIVIL. COM
understand that I will need to Commission and that my applic		a duly authorized age	nt at the meeting of the Planning
Tom Havens			3/24/23
Print Name	Signatur	e	Date
	OFFICE	LISE ONLY	
Received By	Date Received	USE ONLY	Case Number
Submittal Format  □ Electronic □ Paper	Fee Amount Paid		Invoice Number



#### **MEMORANDUM**

**To:** Garden City Planning Commission & Board of Appeals

From: Denise R. Grabowski, AICP, LEED AP, Planning Manager Consultant

**Date:** May 3, 2023

Re: PC 2320 – 1620 Dean Forest Road

Application Type	General Development Plan
Case Number	PC 2320
Applicant	Tom Havens
Name of Project	1620 Dean Forest Road Building Addition
Property Address	1620 Dean Forest Road
Parcel IDs	60988A 02009
Area of Property	1.05 acres
Current Zoning	P-I-2
Proposed Land Use	Mechanical repair shop

#### **GENERAL INFORMATION**

*Project Description*: The applicant is proposing the addition of 5,661 square feet to an existing 12,221 square foot building. The expansion will provide additional workspace for an existing tenant who provides motor repair services.

Pursuant to Section 90-43, Designation of P districts, a general development plan must be submitted for review and approval by the Planning Commission prior to development of the site. The general plan for a proposed P district shall include proposed uses and overall development standards and shall promote an environment of stable and desirable character in harmony with the established or proposed land use pattern in surrounding areas.

#### **FINDINGS**

Staff has determined this application is complete and contains all required information. In conformance with the City of Garden City Zoning Ordinance Section 90-48, the following factors are to be considered for a General Development Plan review:

1. Proposed uses and overall development plan
The proposed use is an expansion of an existing use, permitted in I-2. The building
addition will provide for additional workspace and storage. A small detention area is
located to the rear of the building.



- 2. Façade elevation plan indicating building orientation and scale; exterior construction materials, including texture and color; roof shape, window and door openings, porches, and balconies; architectural style or structure and the facade architectural treatment. The proposed addition is located at the back of the existing structure and will match the existing building.
- 3. Fences, landscaping, and buffers.
  The applicant is providing additional landscaping along Dean Forest Road to screen the parking area.
- 4. Driveway and parking orientation, in keeping with the established character in the area. Access is provided via Morgan Road. A roll-up door is proposed on the addition so trucks can directly access the new workspace area.
- 5. Scale, design, and location of exterior signs. Special sign restrictions may be required based on the location and character of the development and surrounding area.

  No additional signage is proposed. Any signage shall comply with the City of Garden City ordinances and will require a sign permit.

The applicant has provided the required information.

#### RECOMMENDATION

Approval of the General Development Plan.

#### Note:

Approval, if granted, by the Planning Commission only constitutes the initial step in the overall process and additional requirements still must be met prior to commencement of any construction activities. The Petitioner should note that final approval of the site plan will require City staff approval of the detailed engineering plans for the project through the City's standard process and a Land Disturbance Activity (LDA) Permit must be issued prior to construction. The Petitioner should also note that final approval of the site architectural plans will require City staff approval via its standard process and a building permit must be issued before vertical construction shall commence.

## PROJECT DESCRIPTION

ADDITION OF A 5,661 SF METAL BUILDING ONTO AN EXISTING 12,221 SF METAL BUILDING AND ASSOCIATED ACCESS IMPROVEMENTS.

TOTAL AREA OF PROPERTY = 1.051 ACRES TOTAL DEVELOPMENT AREA = 0.32 ACRES

ACCORDING TO THE FLOOD INSURANCE RATE MAP 13051C0129G REVISED AUGUST 16,2018, THIS PROPERTY LIES IN ZONE X, NOT A 100 YEAR FLOOD ZONE.

# PARKING CALCULATIONS

PER GARDEN CITY ORDINANCE, WAREHOUSE USE REQUIRES ONE SPACE PER TWO EMPLOYEES.

EXISTING WAREHOUSE CURRENTLY HAS 2 EMPLOYEES, AND WILL ADD 2 EMPLOYEES AS A RESULT OF ADDED WORKSPACE FOR A TOTAL OF 4 EMPLOYEES.

REQUIRED PARKING=4/2 SPACES PROVIDED EXISTING PARKING = 9 SPACES

9 > 2 = 0K

# **ABBREVIATIONS**

	TIBBRE VIIII	10115	
40	ACCRECATE DACE	444	1417/11/11
AB	AGGREGATE BASE	MAX	MAXIMUM
AC	ASPHALT CONCRETE	MIN	MINIMUM
ADJ	ADJUSTABLE	MISC	MISCELLANEOUS
AGGR	AGGREGATE	MH	MANHOLE
ALT	ALTERNATE	MON	MONUMENT
&	AND	MW	MONITORING WELL
<i>APPROX</i>	APPROXIMATE		
		N	NORTH
<b>@</b>	ΑΤ	(N)	NORTH
		NÓ., #	NUMBER
BC	BACK OF CURB	NTS "	NOT TO SCALE
BCR	BEGIN CURB RETURN		
BGS	BELOW GRADE SURFACE	OC	ON CENTER
BVC	BEGIN VERTICAL CURVE	OH	OVER HEAD
BVCE	BEGIN VERTICAL CURVE ELEVATION	OHE	OVER HEAD ELECTRICAL
BSW	BACK OF SIDEWALK	OHT	OVER HEAD TELEPHONE
BW	TOP OF BOARDWALK DECK	OHU	OVER HEAD UTILITY
		ORN	ORNAMENTAL
CB	CATCH BASIN	UKN	UKIVAMEIVIAL
C&G	CURB AND GUTTER	DAIZ	DAL/ALO
CL	CLASS	PAV	PAVING
Q CO	CENTERLINE	PCC	PORTLAND CEMENT CONCRETE
CO	CLEANOUT	PED	PEDESTRIAN
CONC	CONCRETE	PI	POINT OF INTERSECTION
CLR, CL	CLEARANCE	R	PROPERTY LINE
CMP	Corrugated Metal Pipe	PΡ	POWER POLE
CP	CONTROL POINT	PROP	PROPERTY
CULV	CULVERT	PRC	POINT OF REVERSE CURVE
		PRVC	POINT OF REVERSE VERTICAL CUR
DBC	DEPRESSED BACK OF CURB	PT	POINT
DI	DROP INLET	PVC	POLYVINYL CHLORIDE PIPE
DIA	DIAMETER	PVI	POINT OF VERTICAL INTERSECTION
D/W, DW, DWY	DRIVEWAY	, ,,	TONT OF VERTIONE INTEROCEOTION
טן ווי, טווי, טוויו	DINVENA	R	RADIUS
EA	EACH	RC	RELATIVE COMPACTION
	ELECTRICAL	RCP	REINFORCED CONCRETE PIPE
E, ELEC		REINF	REINFORCED CONCRETE FIFE
EC .	END CURVE		
<b>ECR</b>	END CURB RETURN	REQ	REQUIRED, REQUIREMENT
EG	EXISTING GROUND	RSP	ROCK SLOPE PROTECTION
EL, ELEV	ELEVATION	RT	RIGHT
<i>EP</i>	EDGE OF PAVEMENT	R/W	RIGHT OF WAY
EXIST	EXISTING		
(E)	<i>EAST</i>	S	SLOPE OR SOUTH
EVC	END VERTICAL CURVE	<i>(S)</i>	SOUTH
EVCE	END VERTICAL CURVE ELEVATION	SCHED	SCHEDULE
		SD	STORM DRAIN
FF	FINISHED FLOOR	SECT	SECTION
FG	FINISHED GRADE	SHT	SHEET
FH	FIRE HYDRANT	SL	STREET LIGHT
FL	FLOW LINE	SPEC	SPECIFICATIONS
FT	FEET	SS	SANITARY SEWER
• •	,,	SDMH	STORM DRAIN MANHOLE
		SSMH	SANITARY SEWER MANHOLE
G	GAS	STA	STATION
GB	GRADE BREAK		
GND	GROUND	STD	STANDARD
		ST	STREET
GRAV	GRAVEL CATE MALLE	S/W	SIDEWALK
GV	GATE VALVE	_	
	400470474	<i>T</i>	TELEPHONE
H, HORZ	HORIZONTAL	<i>TB</i>	TOP OF BANK
		TBM	TEMPORARY BENCH MARK
IC	INTERCONNECT	TD	TOP OF DECK (BOARDWALK)
<i>ID</i>	INSIDE DIAMETER	TEL	TELEPHONE
<i>IG</i>	INVERT GRADE	TG	TOP OF GRATE
<i>IN</i>	INCH	TL	TRAFFIC LIGHT
INV	INVERT	TP .	TOP OF PAVEMENT
		 TS	TOP OF SIDEWALK
JP	JOINT POLE	TYP	TYPICAL
JT	JOINT	7V	TELEVISION
JUNCT	JUNCTION	• •	, , , , , , , , , , , , , , , , , ,
•		UG	UNDERGROUND
<i>LF</i>	LINEAR FEET	50	UNDENONUOUND
	LIP OF GUTTER	VC	VERTICAL CURVE
L/G LT	LEFT	VG VG	VALLEY GUTTER
	<b></b> '	<b>7</b> G	VALLE GUITER
		w /	MANTI I


WITH OUT

WATER

# IMPROVEMENT PLANS FOR 1620 DEAN FOREST ROAD BUILDING ADDITION

P.I.N. 60988A 02009

CITY OF GARDEN CITY, GA

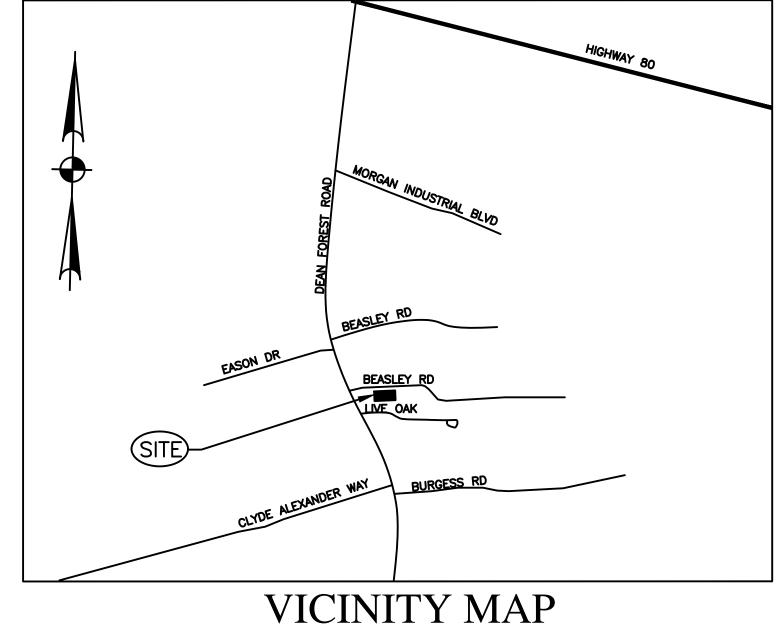

### GENERAL NOTES

1. CONSTRUCTION CONTRACTOR AGREES THAT IN ACCORDANCE WITH GENERALLY ACCEPTED CONSTRUCTION PRACTICES, GENERAL CONTRACTOR WILL BE REQUIRED TO ASSUME SOLE AND COMPLETE RESPONSIBILITY FOR JOB SITE CONDITIONS DURING THE COURSE OF CONSTRUCTION OF THE PROJECT, INCLUDING SAFETY OF ALL PERSONS AND PROPERTY:THAT THIS REQUIREMENT SHALL BE MADE TO APPLY CONTINUOUSLY AND NOT BE LIMITED TO NORMAL WORKING HOURS, AND CONSTRUCTION CONTRACTOR FURTHER AGREES TO HOLD HARMLESS, INDEMNIFY AND DEFEND THE OWNER, THE ARCHITECT, THE ENGINEER AND HIS CONSULTANTS, AND EACH OF THEIR OFFICERS, EMPLOYEES, AND AGENTS.

NO SCALE

- 2. THE CONTRACTOR SHALL INDEPENDENTLY REVIEW GROUND, TOPOGRAPHY, AND TREE CONDITIONS THROUGHOUT THE SITE, AND ASSUME WHOLEY AND UNCONDITIONALLY THE RISK OF COMPLETING THE WORK SET OUT IN THESE PLANS, REGARDLESS OF ROCK, WATER TABLE, OR OTHER CONDITIONS WHICH THE CONTRACTOR MAY ENCOUNTER IN THE COURSE OF THE WORK.
- 3. ANY DISCREPANCY DISCOVERED BY THE CONTRACTOR IN THESE PLANS OR ANY FIELD CONDITIONS DISCOVERED BY THE CONTRACTOR THAT MAY DELAY OR OBSTRUCT THE PROPER COMPLETION OF THE WORK PER THESE PLANS SHALL BE BROUGHT TO THE ATTENTION OF THE ENGINEER AND THE OWNER IMMEDIATELY UPON DISCOVERY. SAID NOTIFICATION SHALL BE IN
- 4 NO GUARANTEE IS INTENDED THAT UNDERGROUND UTILITIES OR OBSTRUCTIONS NOT SHOWN ON THESE PLANS MAY NOT BE ENCOUNTERED. THOSE SHOWN ARE BASED ON THE BEST INFORMATION AVAILABLE AND THE CONTRACTOR IS CAUTIONED THAT THE OWNERS, THE ENGINEERS, AND THE ARCHITECT ASSUME NO RESPONSIBILITY FOR ANY EXISTING UTILITIES OR OBSTRUCTIONS, EITHER SHOWN OR NOT ON THESE PLANS.
- 5 THE CONTRACTOR SHALL NOT BEGIN EXCAVATION UNTIL ALL EXISTING UTILITIES HAVE BEEN MARKED IN THE FIELD. THE CONTRACTOR SHALL NOTIFY THE UTILITIES PROTECTION CENTER AT LEAST THREE WORKING DAYS PRIOR TO EXCAVATION (800) 282-7411.
- 6. ALL GRADING SHALL BE IN CONFORMANCE WITH APPLICABLE PROVISIONS OF THE UBC, THE PROJECT GEOTECHNICAL REPORT, AND CITY OF GARDEN CITY STANDARDS. THE CONTRACTOR SHALL BE RESPONSIBLE FOR COORDINATING WORK WITH THE SOILS ENGINEER.
- 7. ALL UNUSABLE MATERIAL, STUMPS, TREES, BOULDERS AND EXCESS SOIL SHALL BE REMOVED AND DISPOSED OF OFF THE PROJECT SITE UNLESS OTHERWISE PERMITTED BY THE OWNER. 8. NO JETTING OR FLOODING OF BACKFILL SHALL BE PERMITTED.
- 9. THE CONTRACTOR SHALL BE RESPONSIBLE FOR CLEANING PAVED ROADS OF DIRT, MUD. AND DEBRIS CAUSED BY HIS CONSTRUCTION OPERATIONS. MUD. DIRT AND DEBRIS SHALL BE REMOVED DAILY. SHOULD THESE ITEMS CONSTITUTE A PUBLIC HAZARD OR NUISANCE, THEY SHALL BE REMOVED IMMEDIATELY. THE CONTRACTOR SHALL PROMPTLY CLEAN STREETS WHEN REQUESTED BY THE DESIGNATED REPRESENTATIVE OF CITY OF GARDEN CITY.
- 10. GRADING EQUIPMENT SHALL BE ADEQUATELY MUFFLED TO REDUCE THE NOISE IMPACT ON ADJACENT PROPERTIES. EQUIPMENT SHALL NOT OPERATE ON THE SITE PRIOR TO 8 A.M. OR AFTER 5 P.M ON WEEKDAYS, AND SHALL NOT BE OPERATED ON WEEKENDS OR HOLIDAYS.
- 11.ANY MATERIALS, WORKMANSHIP, AND CONSTRUCTION WITHIN GARDEN CITY RIGHT-OF-WAY SHALL CONFORM TO THE CITY TECHNICAL SPECIFICATIONS AND STANDARD CONSTRUCTION DETAILS.
- 12. ALL WORK AND EQUIPMENT SHALL COMPLY WITH OSHA REQUIREMENTS.
- 13. THE CONTRACTOR SHALL OBTAIN AN ENCROACHMENT PERMIT PRIOR TO BEGINNING ANY WORK IN ANY ROADWAY, RIGHT-OF-WAY, ETC. FROM GARDEN CITY.
- 14. CHLORINATED DISINFECTED WATER SHALL NOT BE DISCHARGED INTO THE STORMWATER SYSTEM. 15. ALL TRENCH BEDDING AND BACKFILL SHALL BE PER MANUFACTURER'S RECOMMENDATIONS AND
- DETAILS ON DRAWINGS. 16. DUST CONTROL MEASURES SHALL BE INSTITUTED DURING GRADING ACTIVITIES TO PREVENT
- A DUST NUISANCE TO ADJACENT PUBLIC AND PRIVATE PROPERTIES. 17. THE CONTRACTOR SHALL OBTAIN A SITE GRADING PERMIT FROM GARDEN CITY PRIOR TO THE COMMENCEMENT OF ANY GRADING ON THE SITE.

# LEGEND

COVER SHEET

**EXISTING CONDITIONS** 

MISCELLANEOUS DETAILS

GRADING AND DRAINAGE PLAN

EROSION & SEDIMENT CONTROL PLAN

CIVIL SITE LAYOUT

ARCHITECT

ON ARCHITECTURE 224 OVERLOOK DRIVE

DALLAS, GA 30157

**ONILÉS@ONARCHITECTUREATL.COM** 


**INDEX TO SHEETS** 

(404)409-5427

SHEET C3

OWEN NILES

	LEGENI	<del>_</del>
	<u>EXISTING</u>	<u>PROPOSED</u>
6" SS	SANITARY SEWER	6" SS
•	SANITARY SEWER CLEANOUT	•
\$	SANITARY SEWER MANHOLE	<b>S</b>
$\triangle$	CONTROL POINT	
•	CITY MONUMENT	$oldsymbol{\odot}$
TS	TRAFFIC SIGNAL	TS
	SPLICE BOX	О
□ MB	MAILBOX	□ MB ————————————————————————————————————
12" SD MH	DRIVEWAY	12" SD MH
12 30	STORM DRAIN W/MANHOLE	
Τ	TELEPHONE	<i>r</i>
EXIST 6" W	WATER	6" W
E	ELECTRIC	
<u>EXIST G</u> AS	—— GAS	EXIST GAS
R/W	APPROXIMATE RIGHT OF WAY LINE	κ <b>/ "</b>
BACK	STREET ADDRESS  CK OF SIDEWALK	BACK OF SIDEWALK
FACE	SIDEWALK/CURB & GUTTER OF GUTTER	FACE OF CURB  LIP OF GUTTER
$\circ$	STORM DRAIN MANHOLE	0
SL	STREET LIGHT CONDUIT	SL
	HANDICAP RAMP	
	WATER VALVE	<b>●</b>
- <b>∳</b> -FH	FIRE HYDRANT	- <b>∳</b> -FH
□ WM	WATER METER	□ WM
•	MONITORING WELL	•
	DROP INLET	
	TREE	EED
	CATCH BASIN	<b>©</b>
€ <b>◊</b>	POLE AND GUY WIRE	e
	STRIPING	
~ <del>&gt;</del> -<	STREET LIGHT	~ <del>}</del> ~
•	POLE	•
<del>-</del> <del>- </del>	SINGLE POST SIGN	<del>- o -</del>
	PAVEMENT MARKERS	
	EDGE OF PAVEMENT	
	PRESERVE TREE	BRICK SIDEWALK
	REMOVE TREE	
	CONCRETE PAVING	LITH ITIES SOSTESTION SENTED
	SIDEWALK  SIDEWALK	UTILITIES PROTECTION CENTER  CALL THREE WORKING DAYS  BEFORE YOU DIG  THROUGHOUT GEORGIA
	EROSION CONTROL SEED APPLICATION	811
	BENCHMARK LOCATION	NOTE: CITY OF GARDEN CITY RETAINS THE RIGHT TO ACCESS PROPERTY TO INSPECT STORMWATER
REN	NCH MARK	FACILITIES.

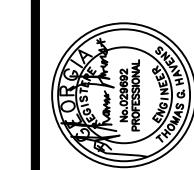

DEVELOPER/OWNER

1620 DEAN FOREST LLC

SAVANNAH, GA 31414

RYAN HUGHES

P.O. BOX 5982

(912)662-2750

RYAN@CORECD.COM

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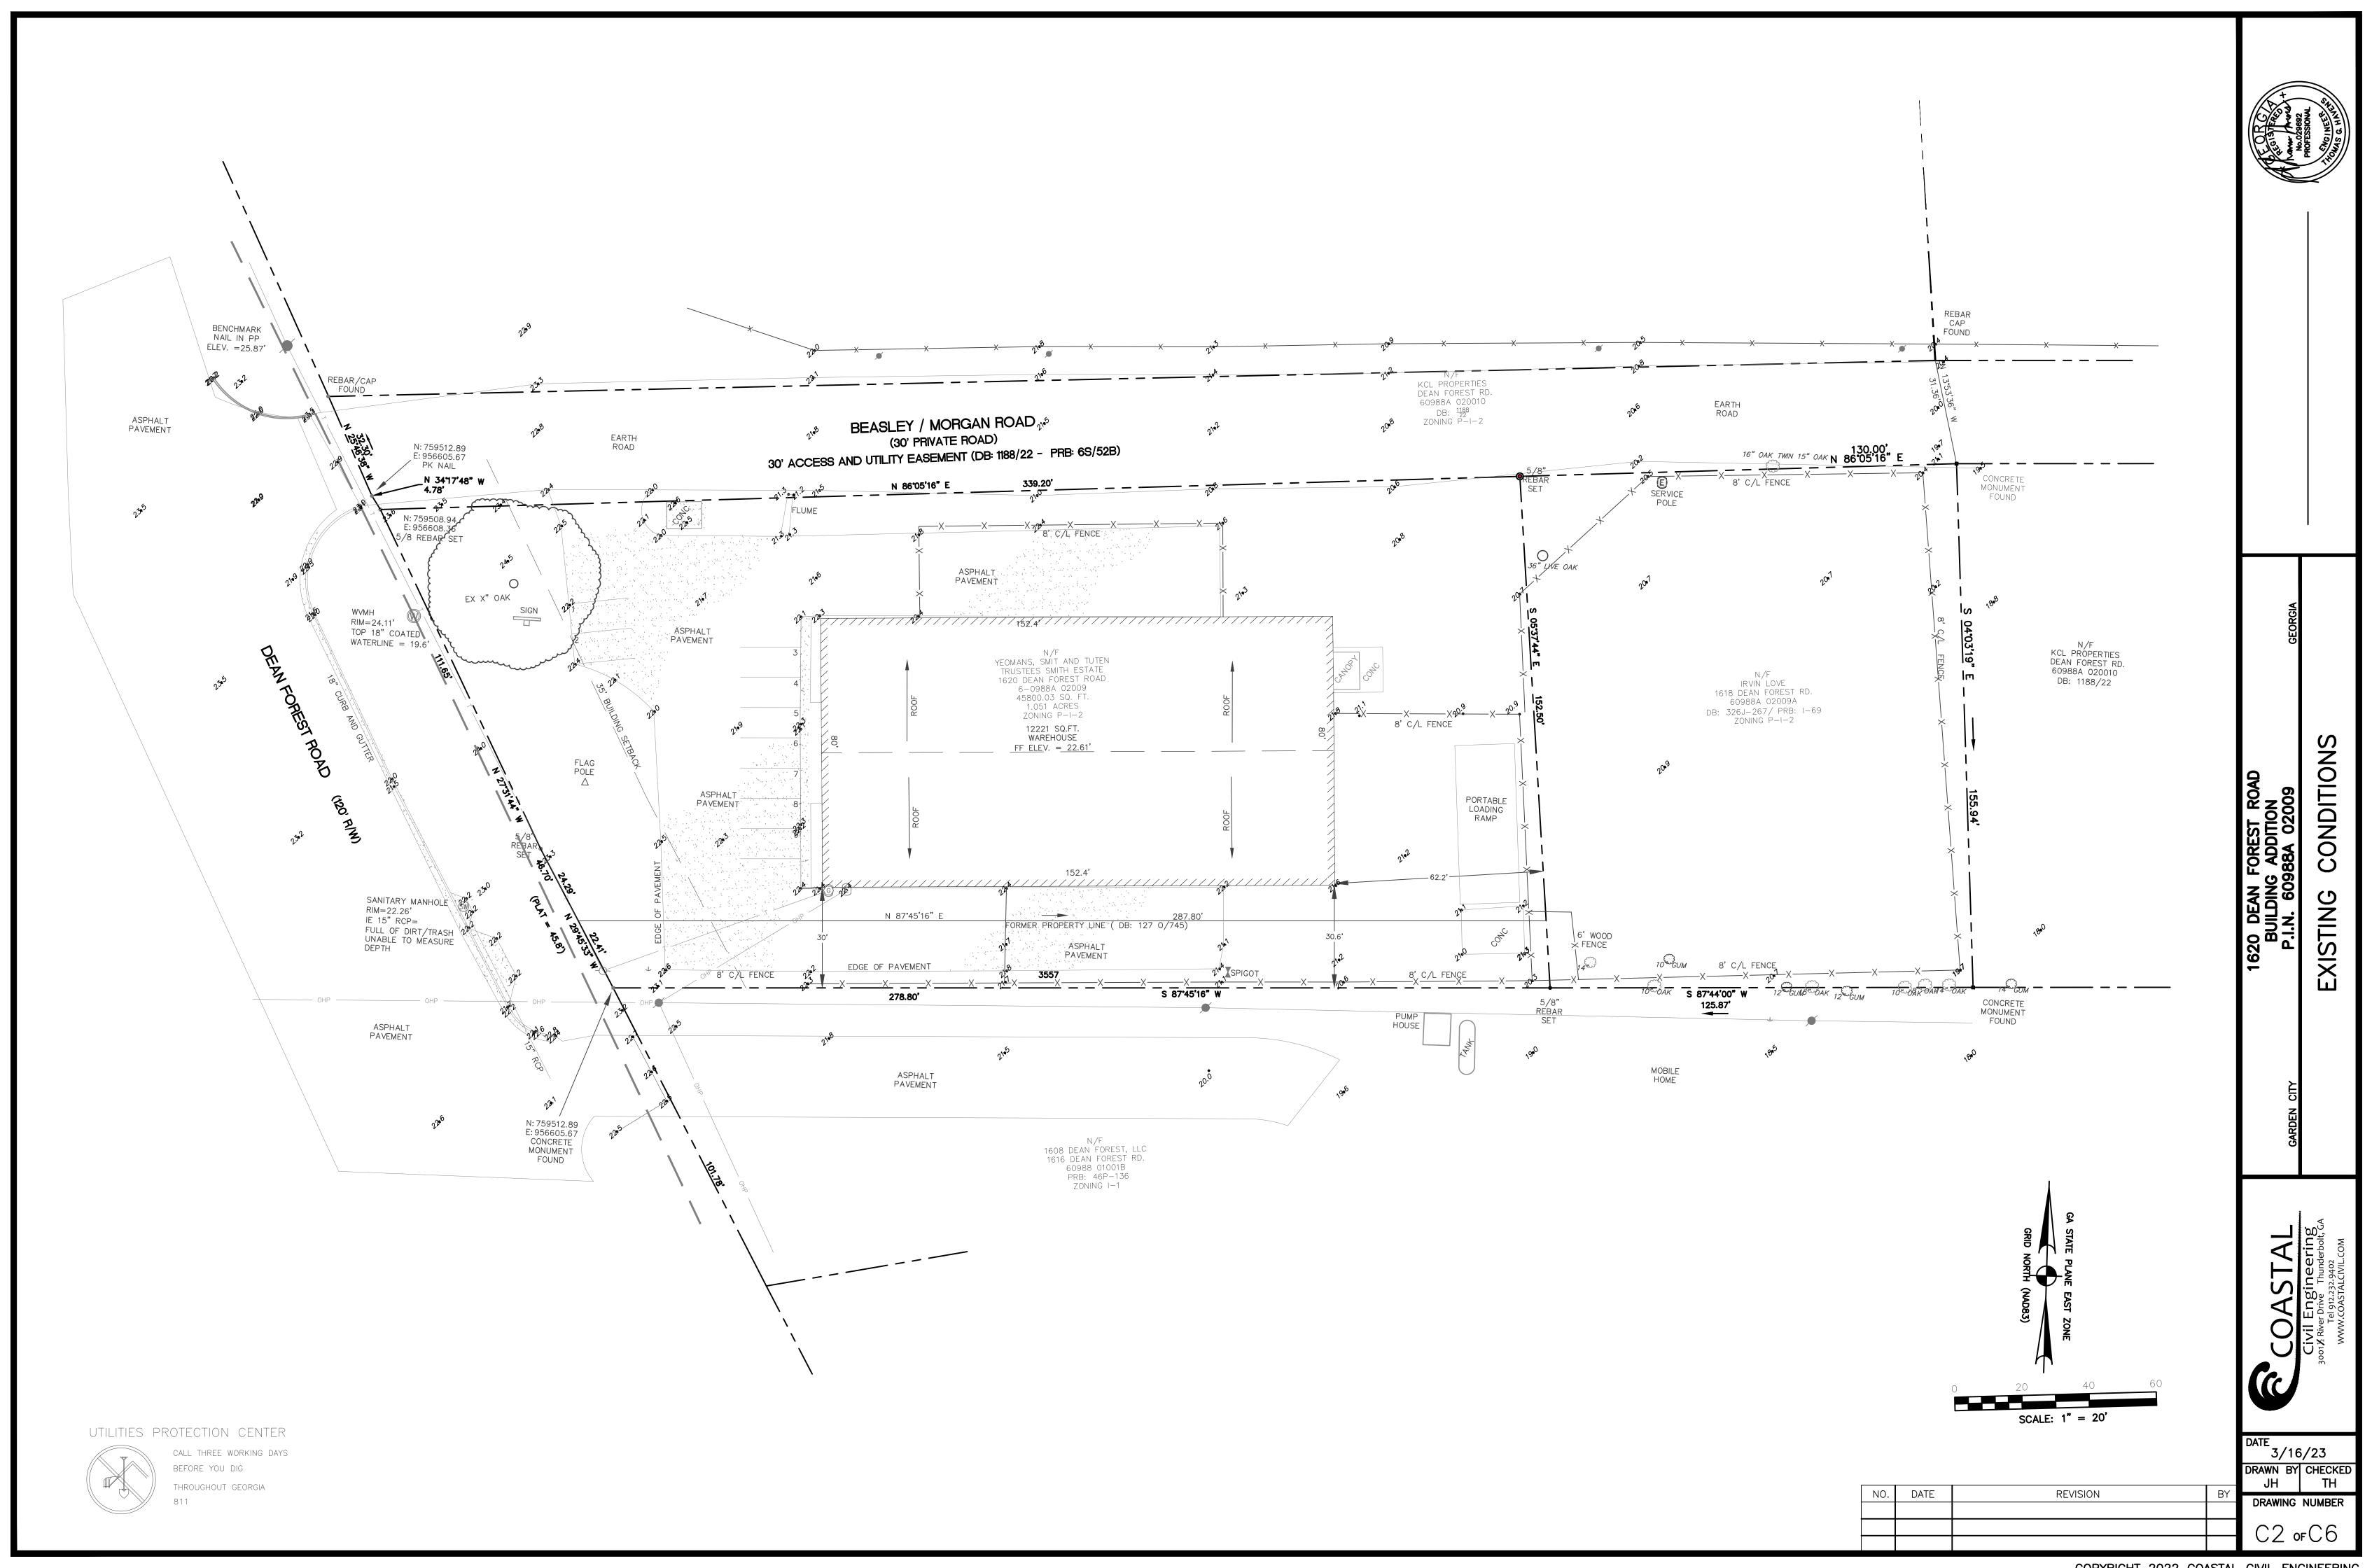
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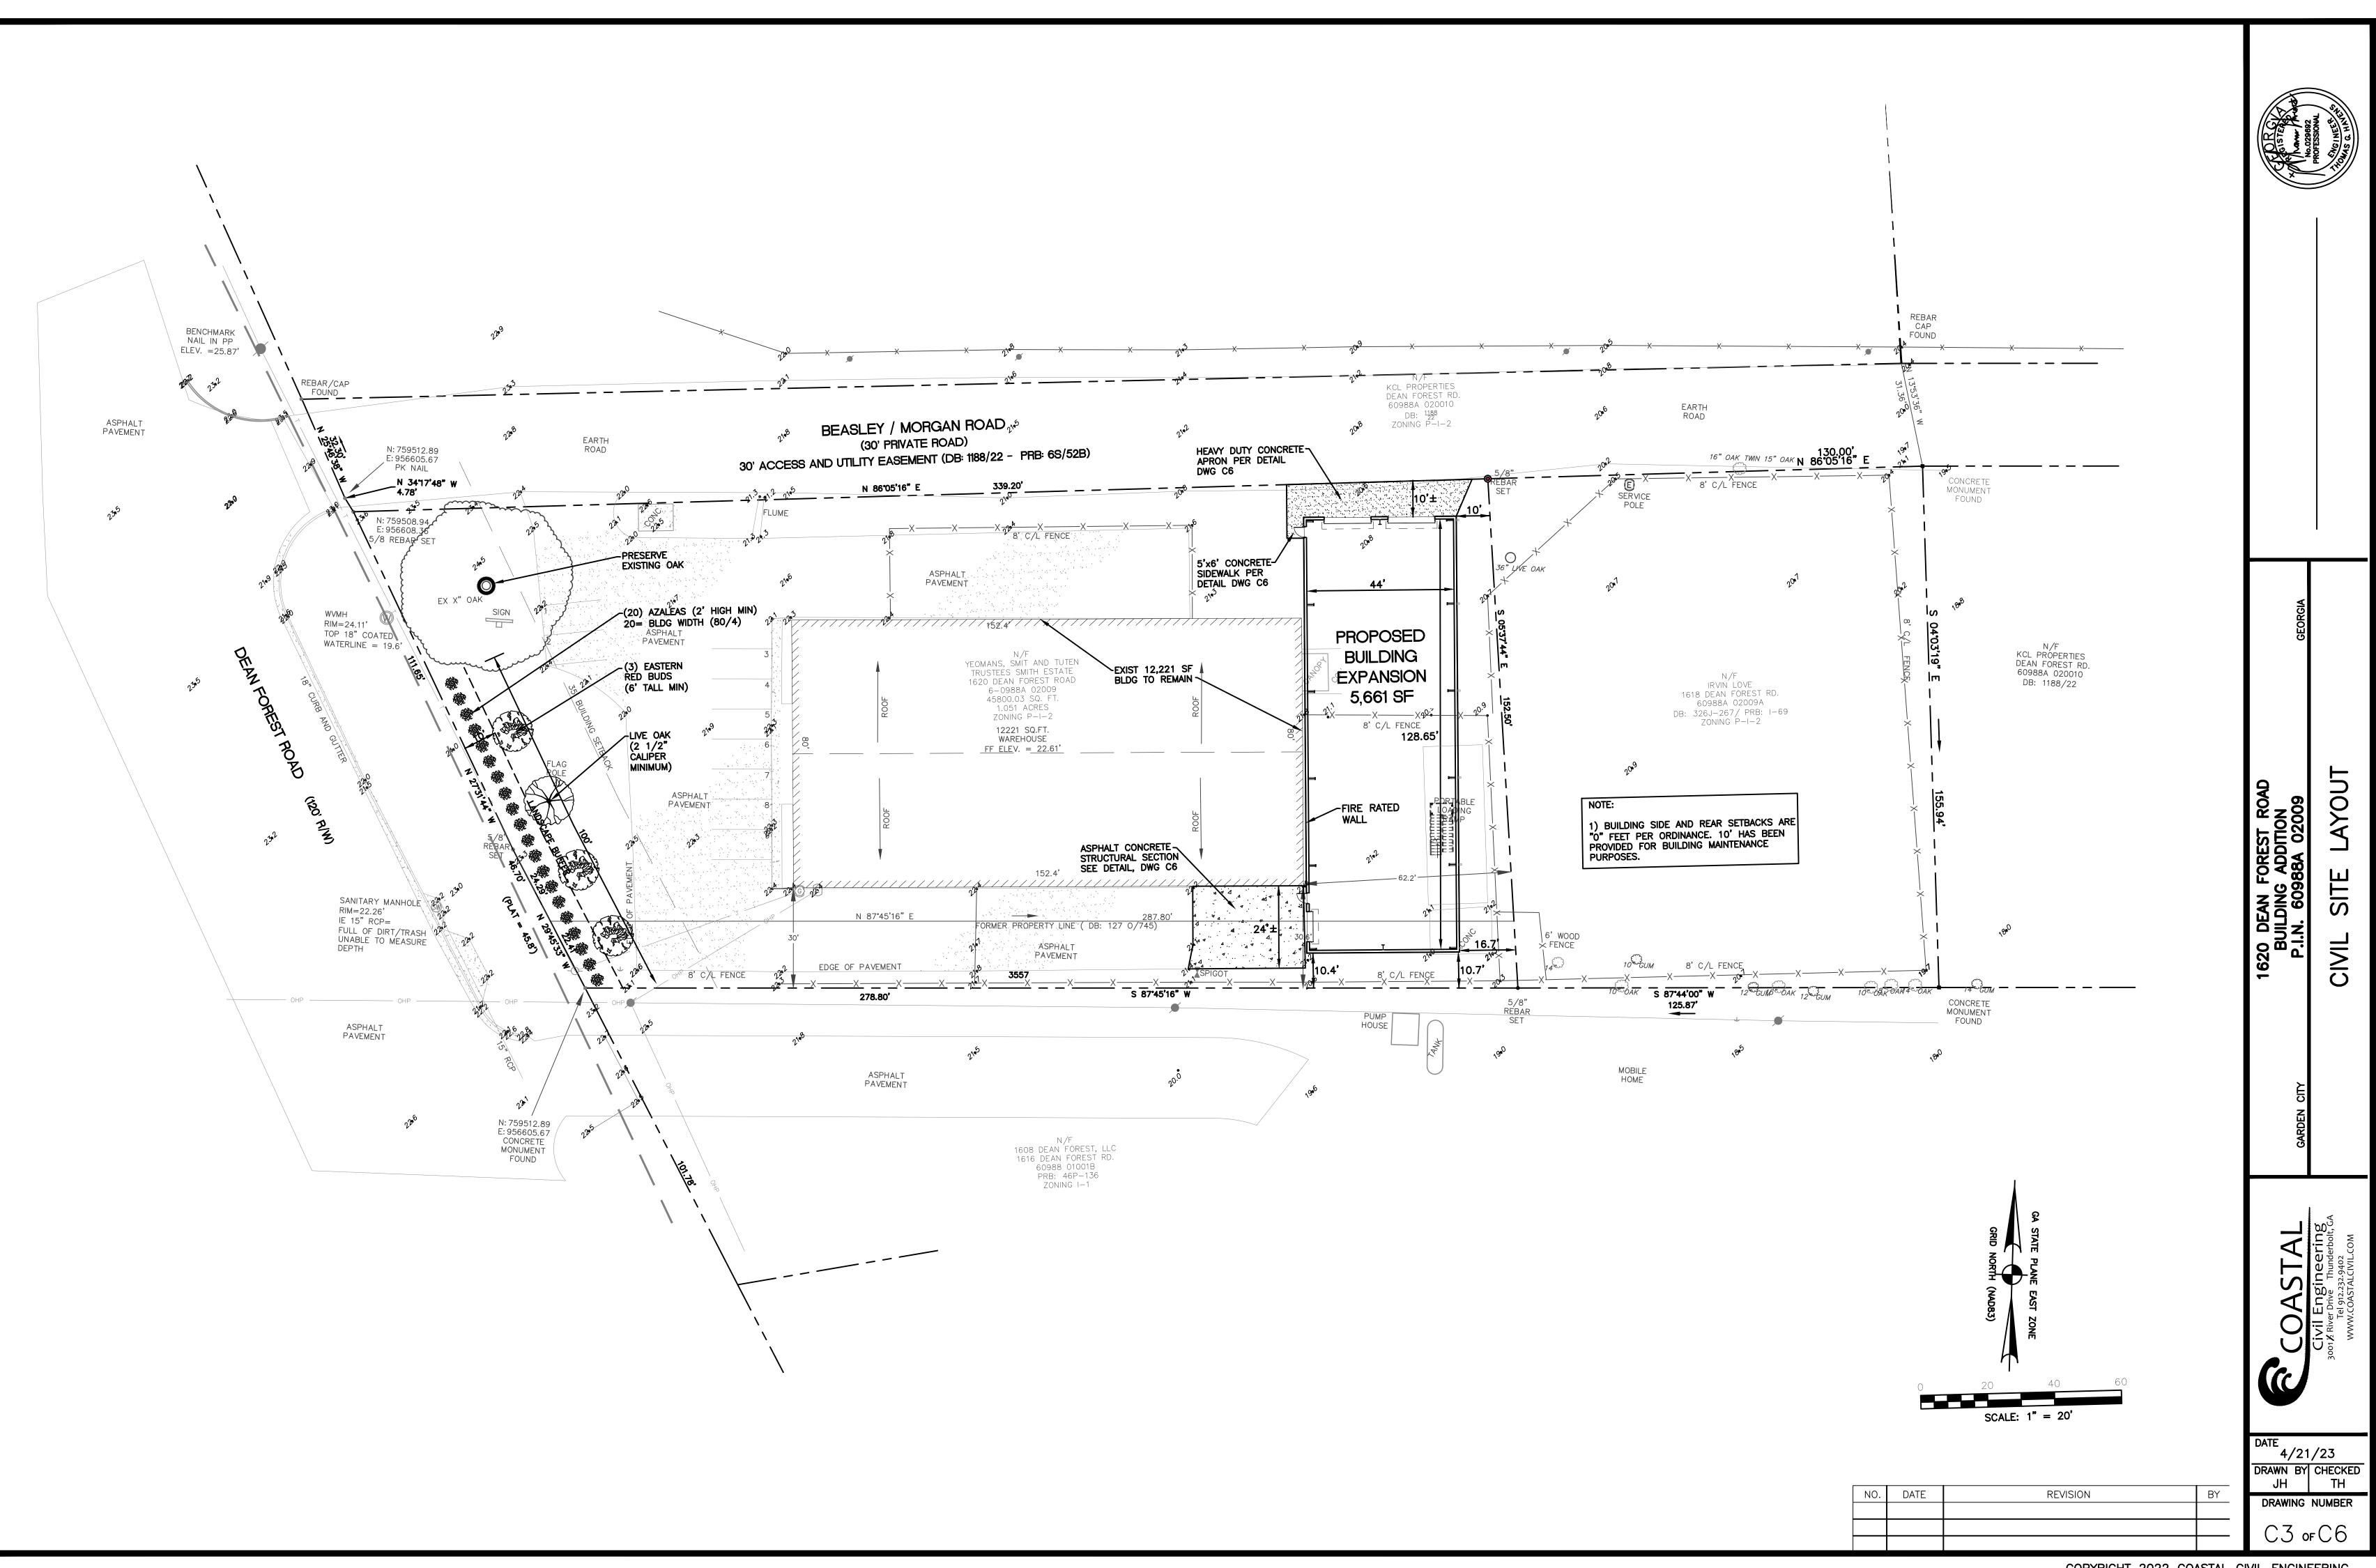
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FACILITIES. **BENCH MARK** DATE REVISION NAIL IN PP


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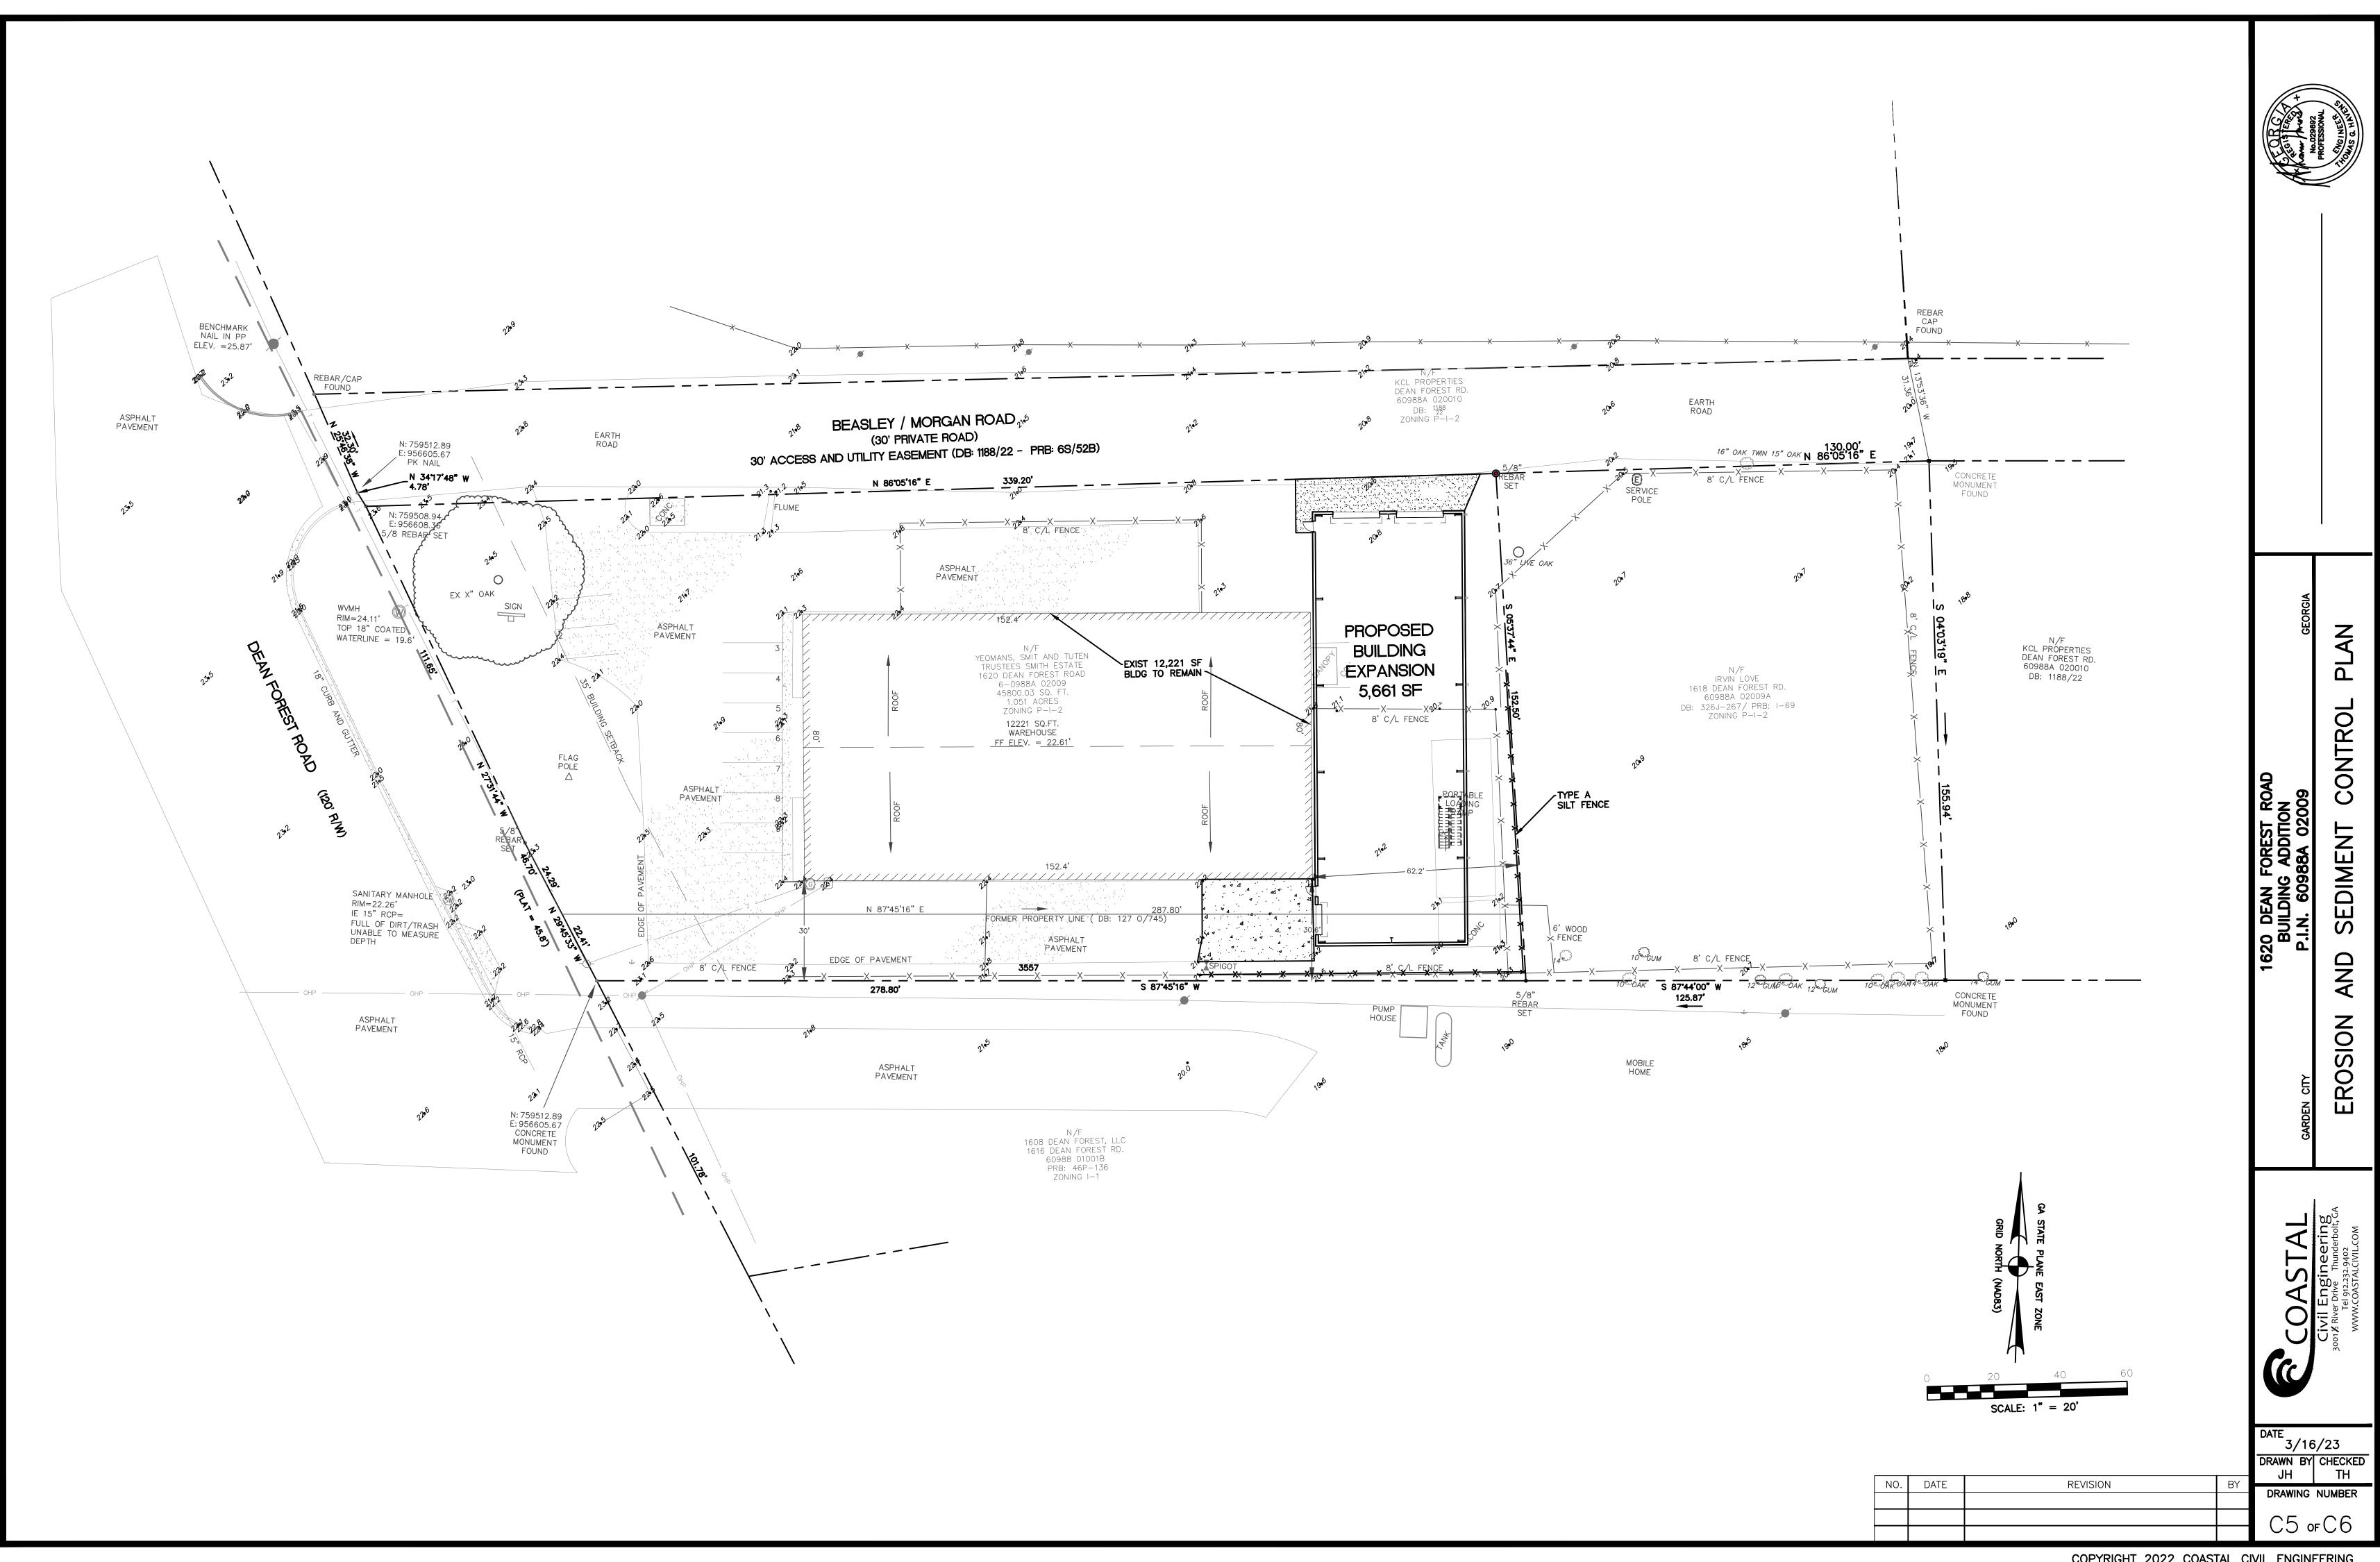



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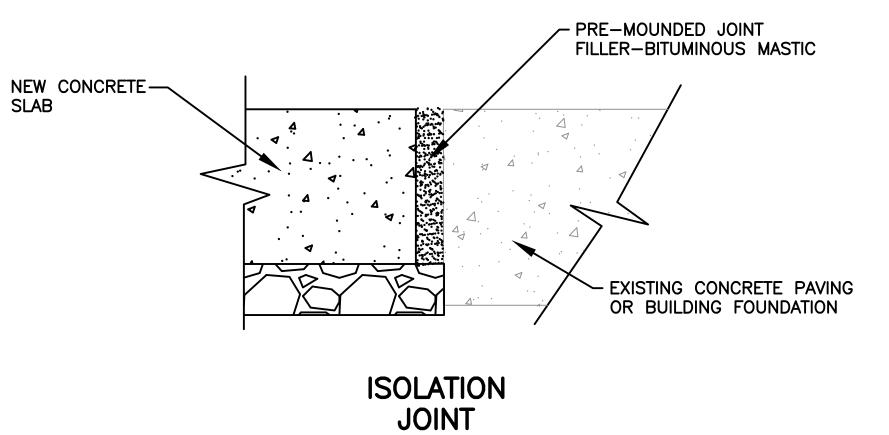



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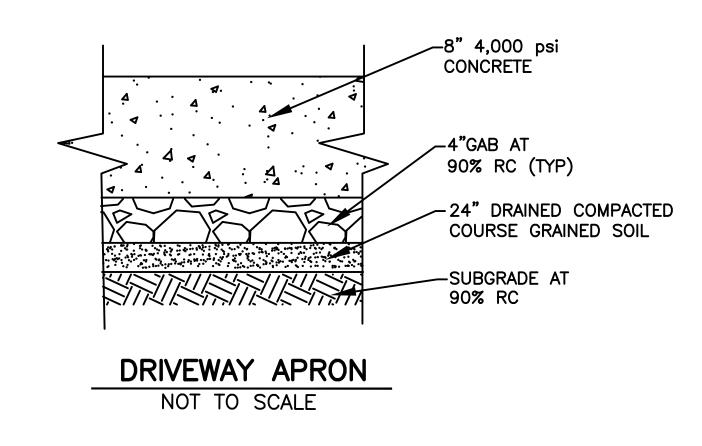
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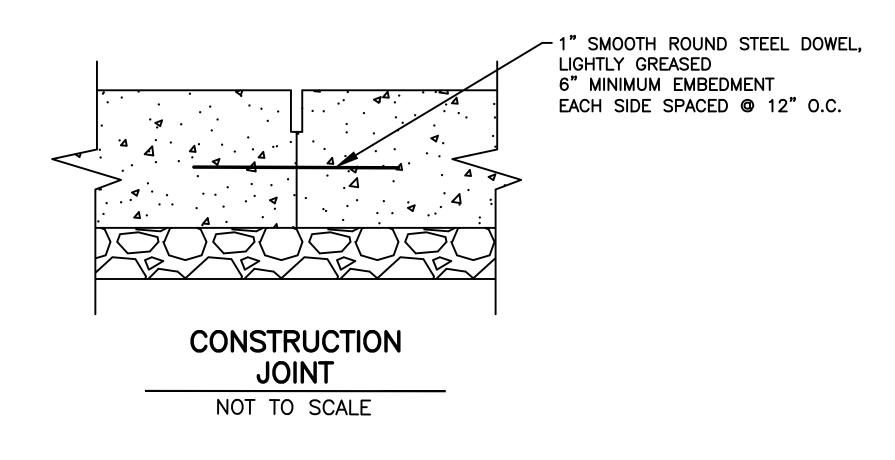








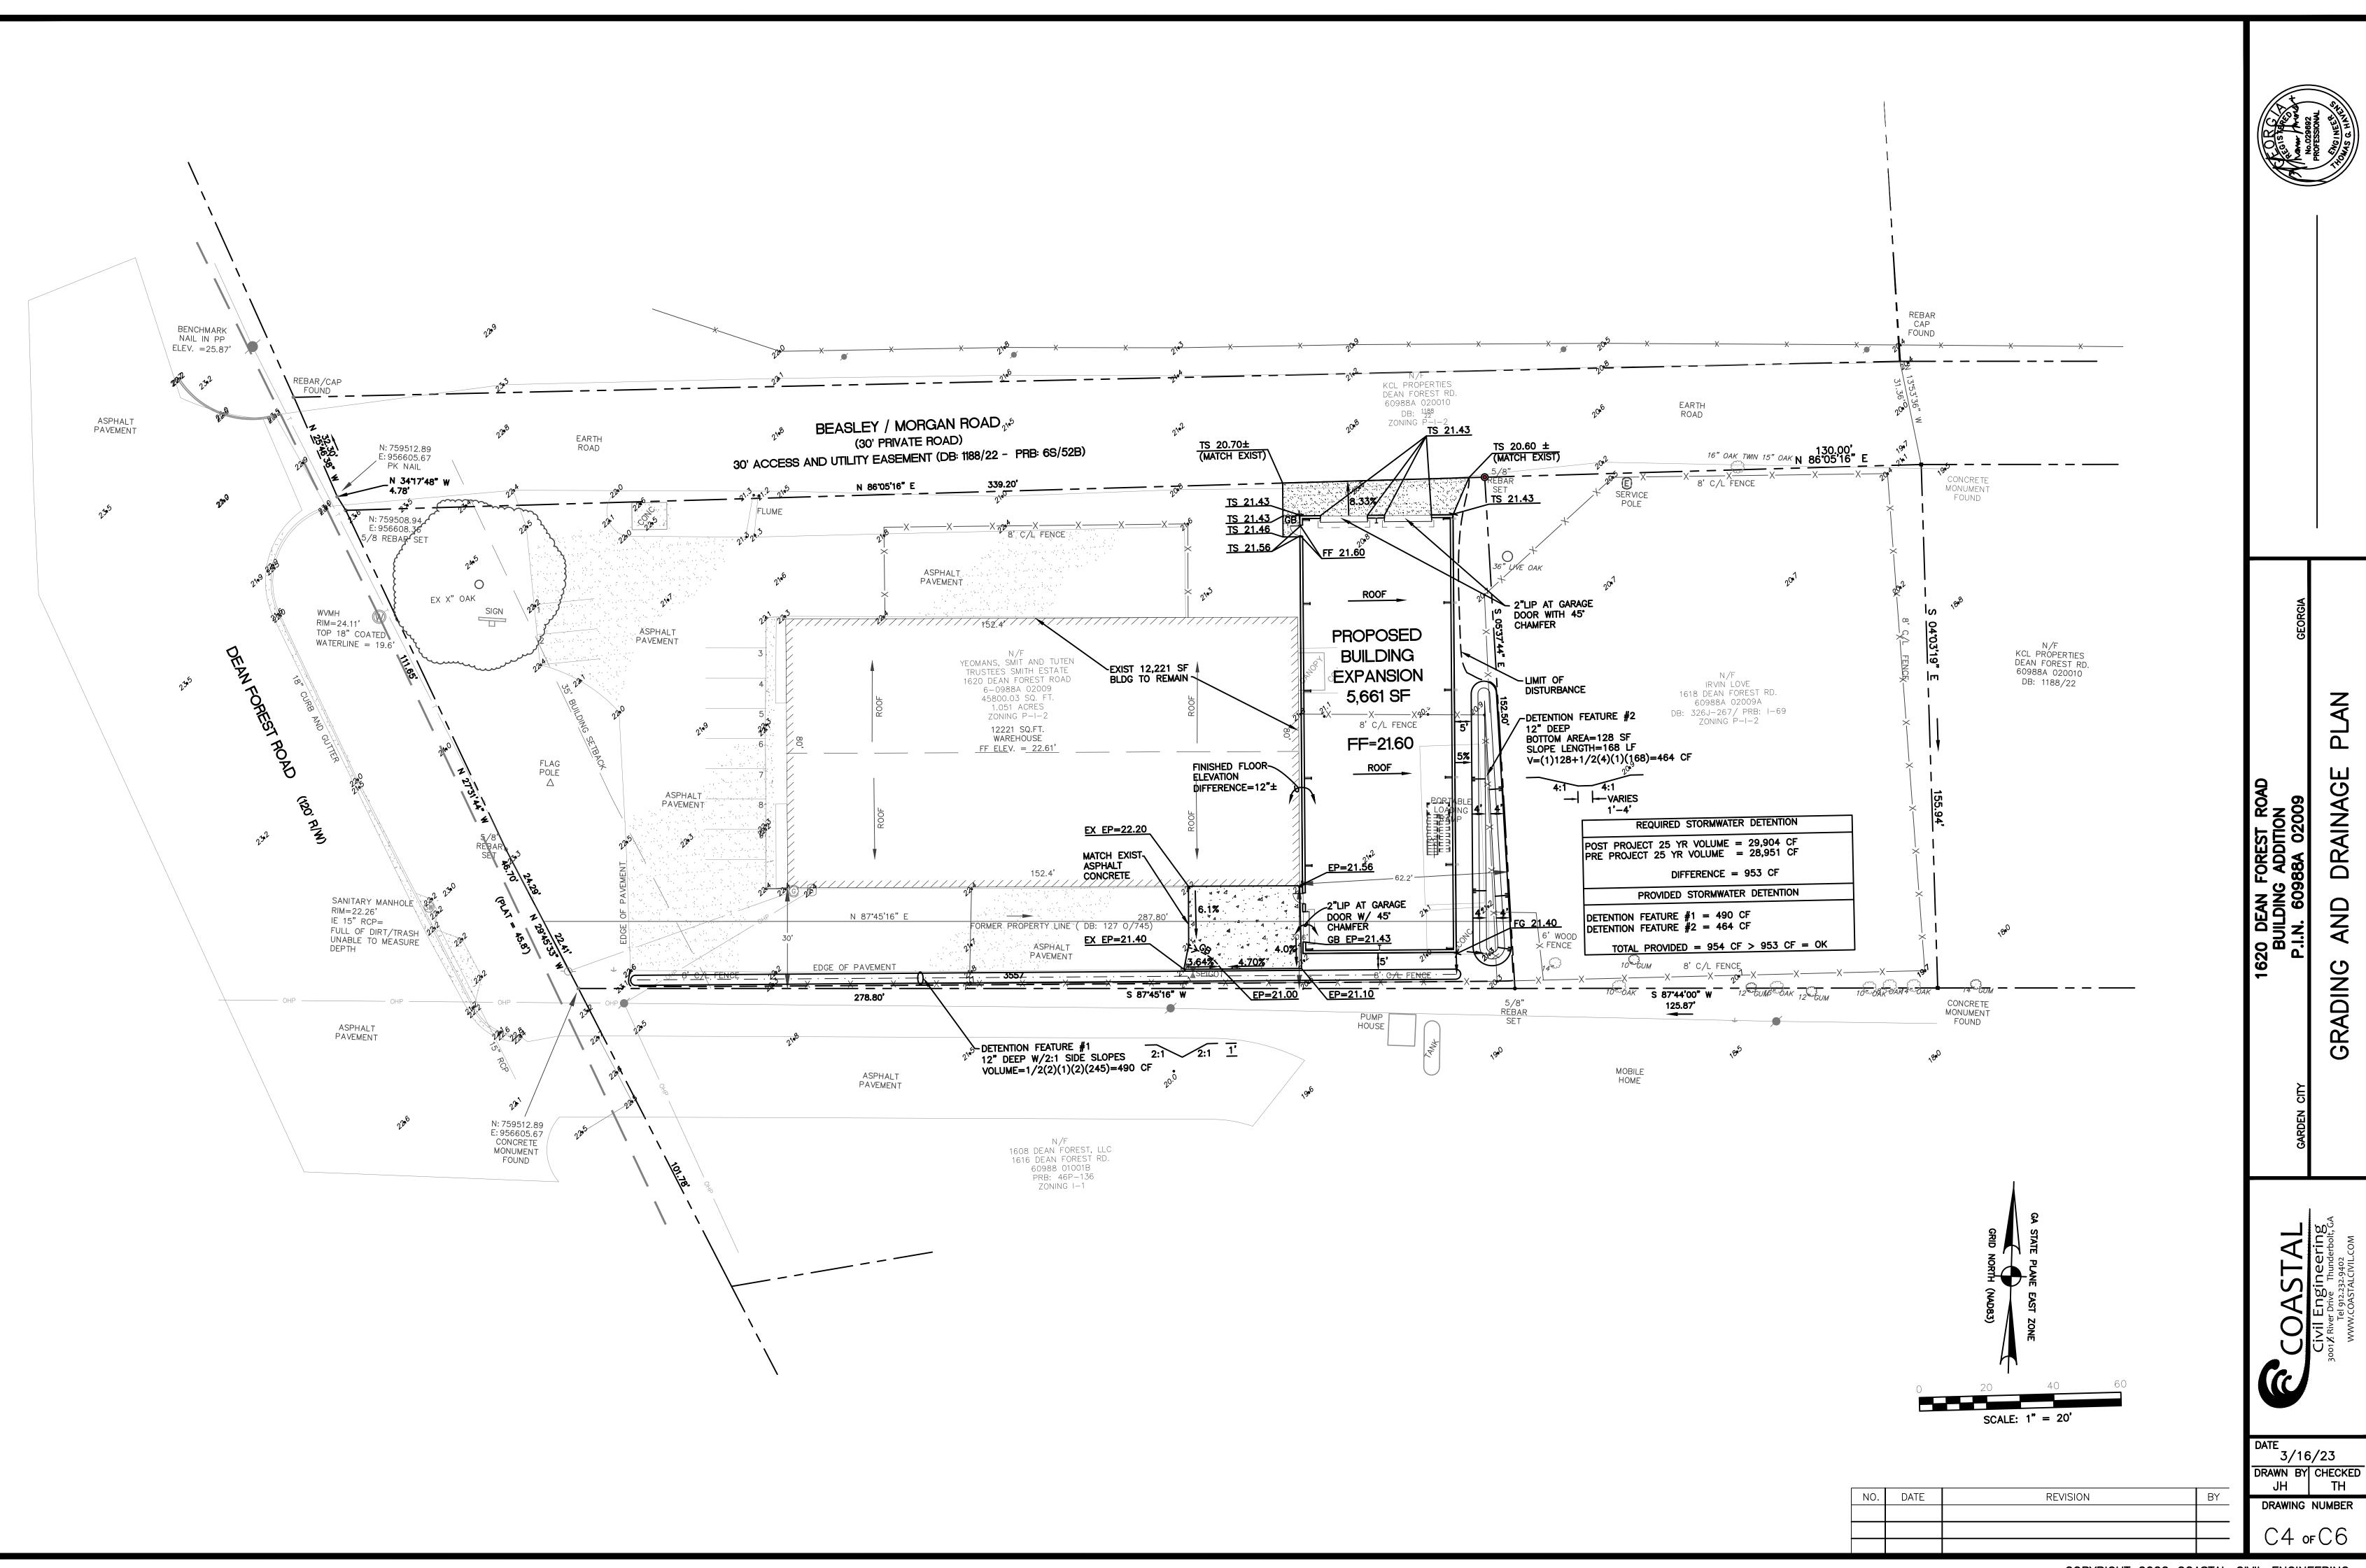

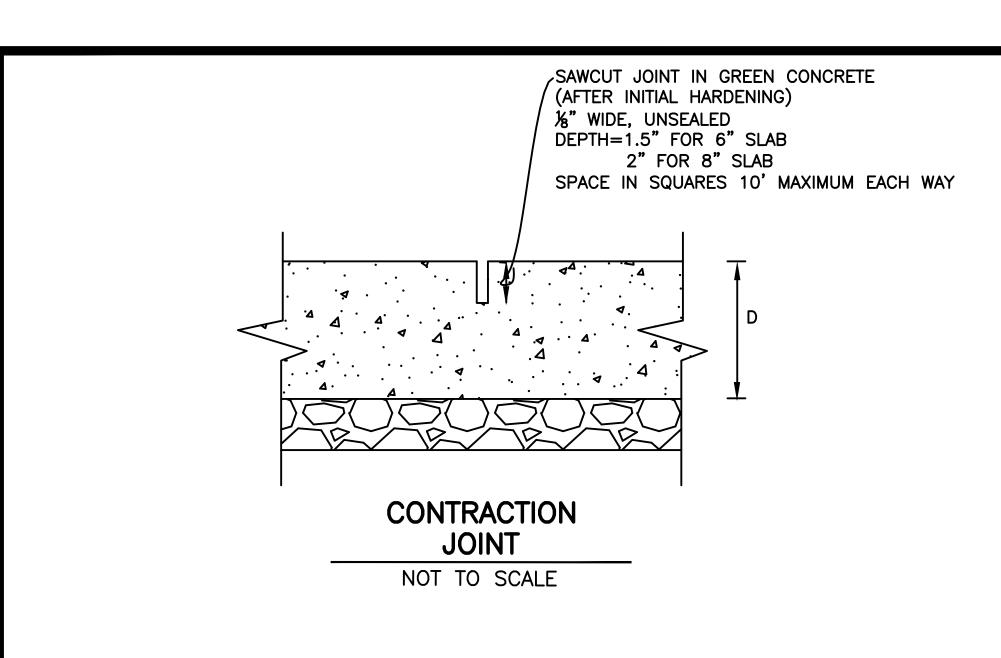

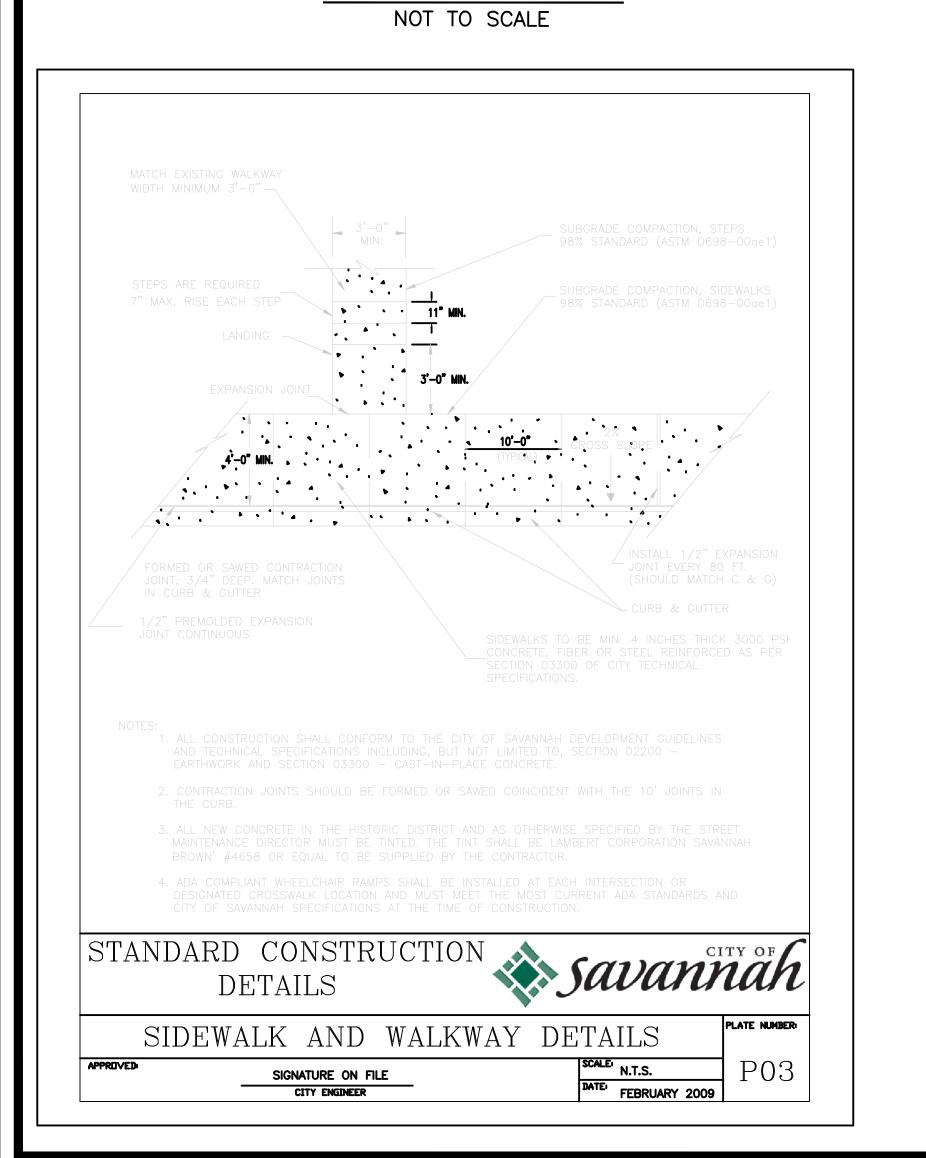

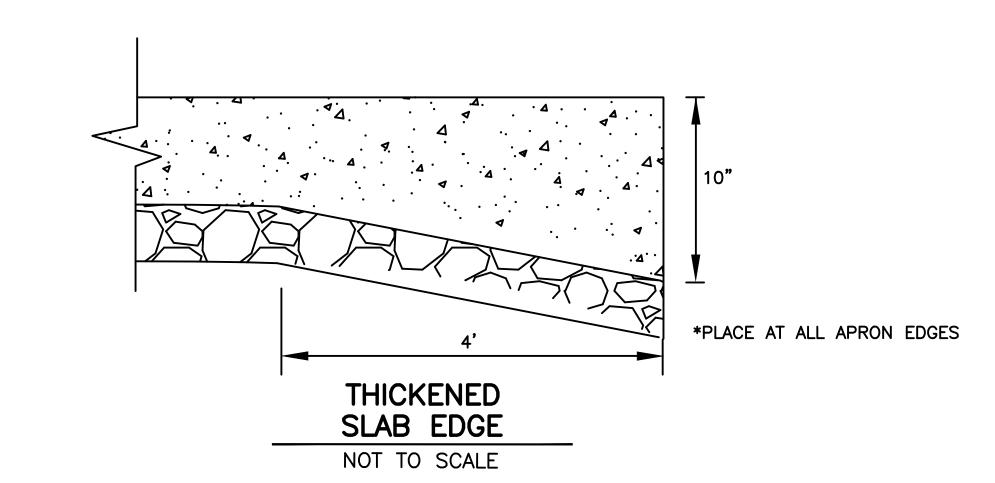

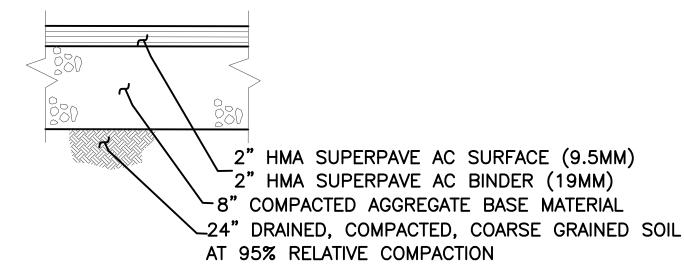


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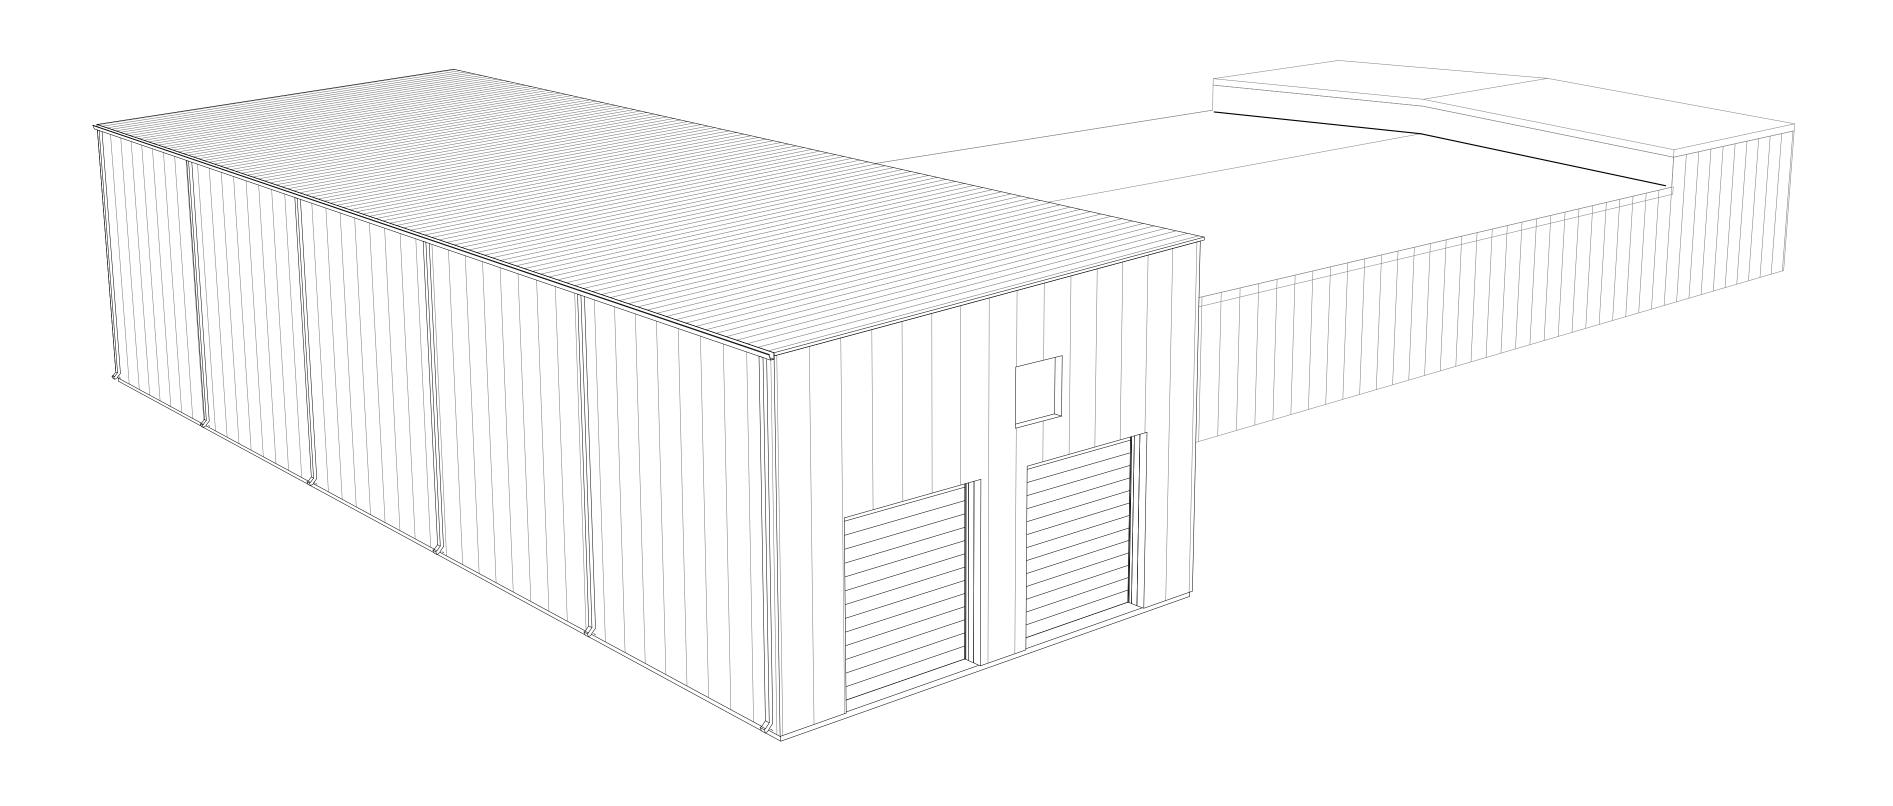
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# 1620 DEAN FOREST, LLC

# BUILDING EXPANSION

1620 DEAN FOREST RD, SAVANNAH GA 31408

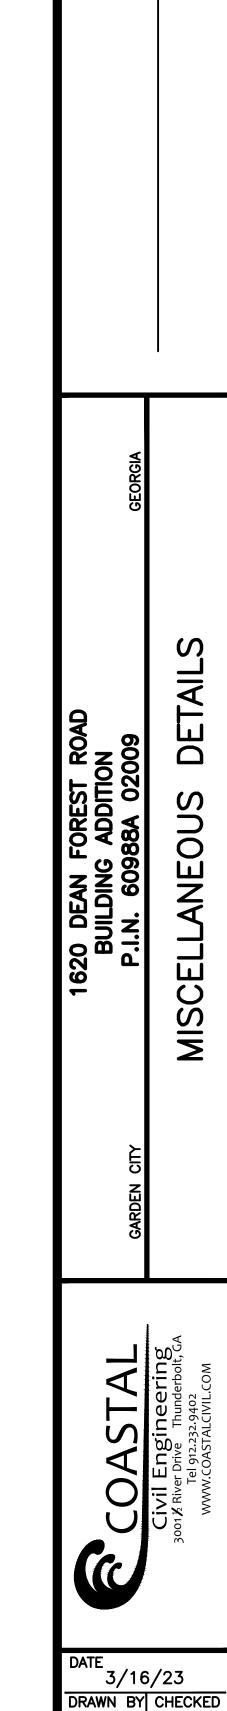

	DRAWING INDEX		
Sheet Number	Sheet Name	PROJECT STATUS	REV
A001	COVER SHEET	PRELIMINARY- FOR REVIEW	
A100	FLOOR PLANS	PRELIMINARY- FOR REVIEW	
A101	ROOF PLAN	PRELIMINARY- FOR REVIEW	
A200	BUILDING ELEVATIONS	PRELIMINARY- FOR REVIEW	
A300	BUILDING SECTIONS	PRELIMINARY- FOR REVIEW	



A INNO

Consultant
Address
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Phone
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1620 DEAN FOREST, LI
BUILDING EXPANSION
1620 Dean Forest Rd, Savannah GA

No.	Description	Date


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Date 03/04

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FOR REVIEW

OVER SHEET A001



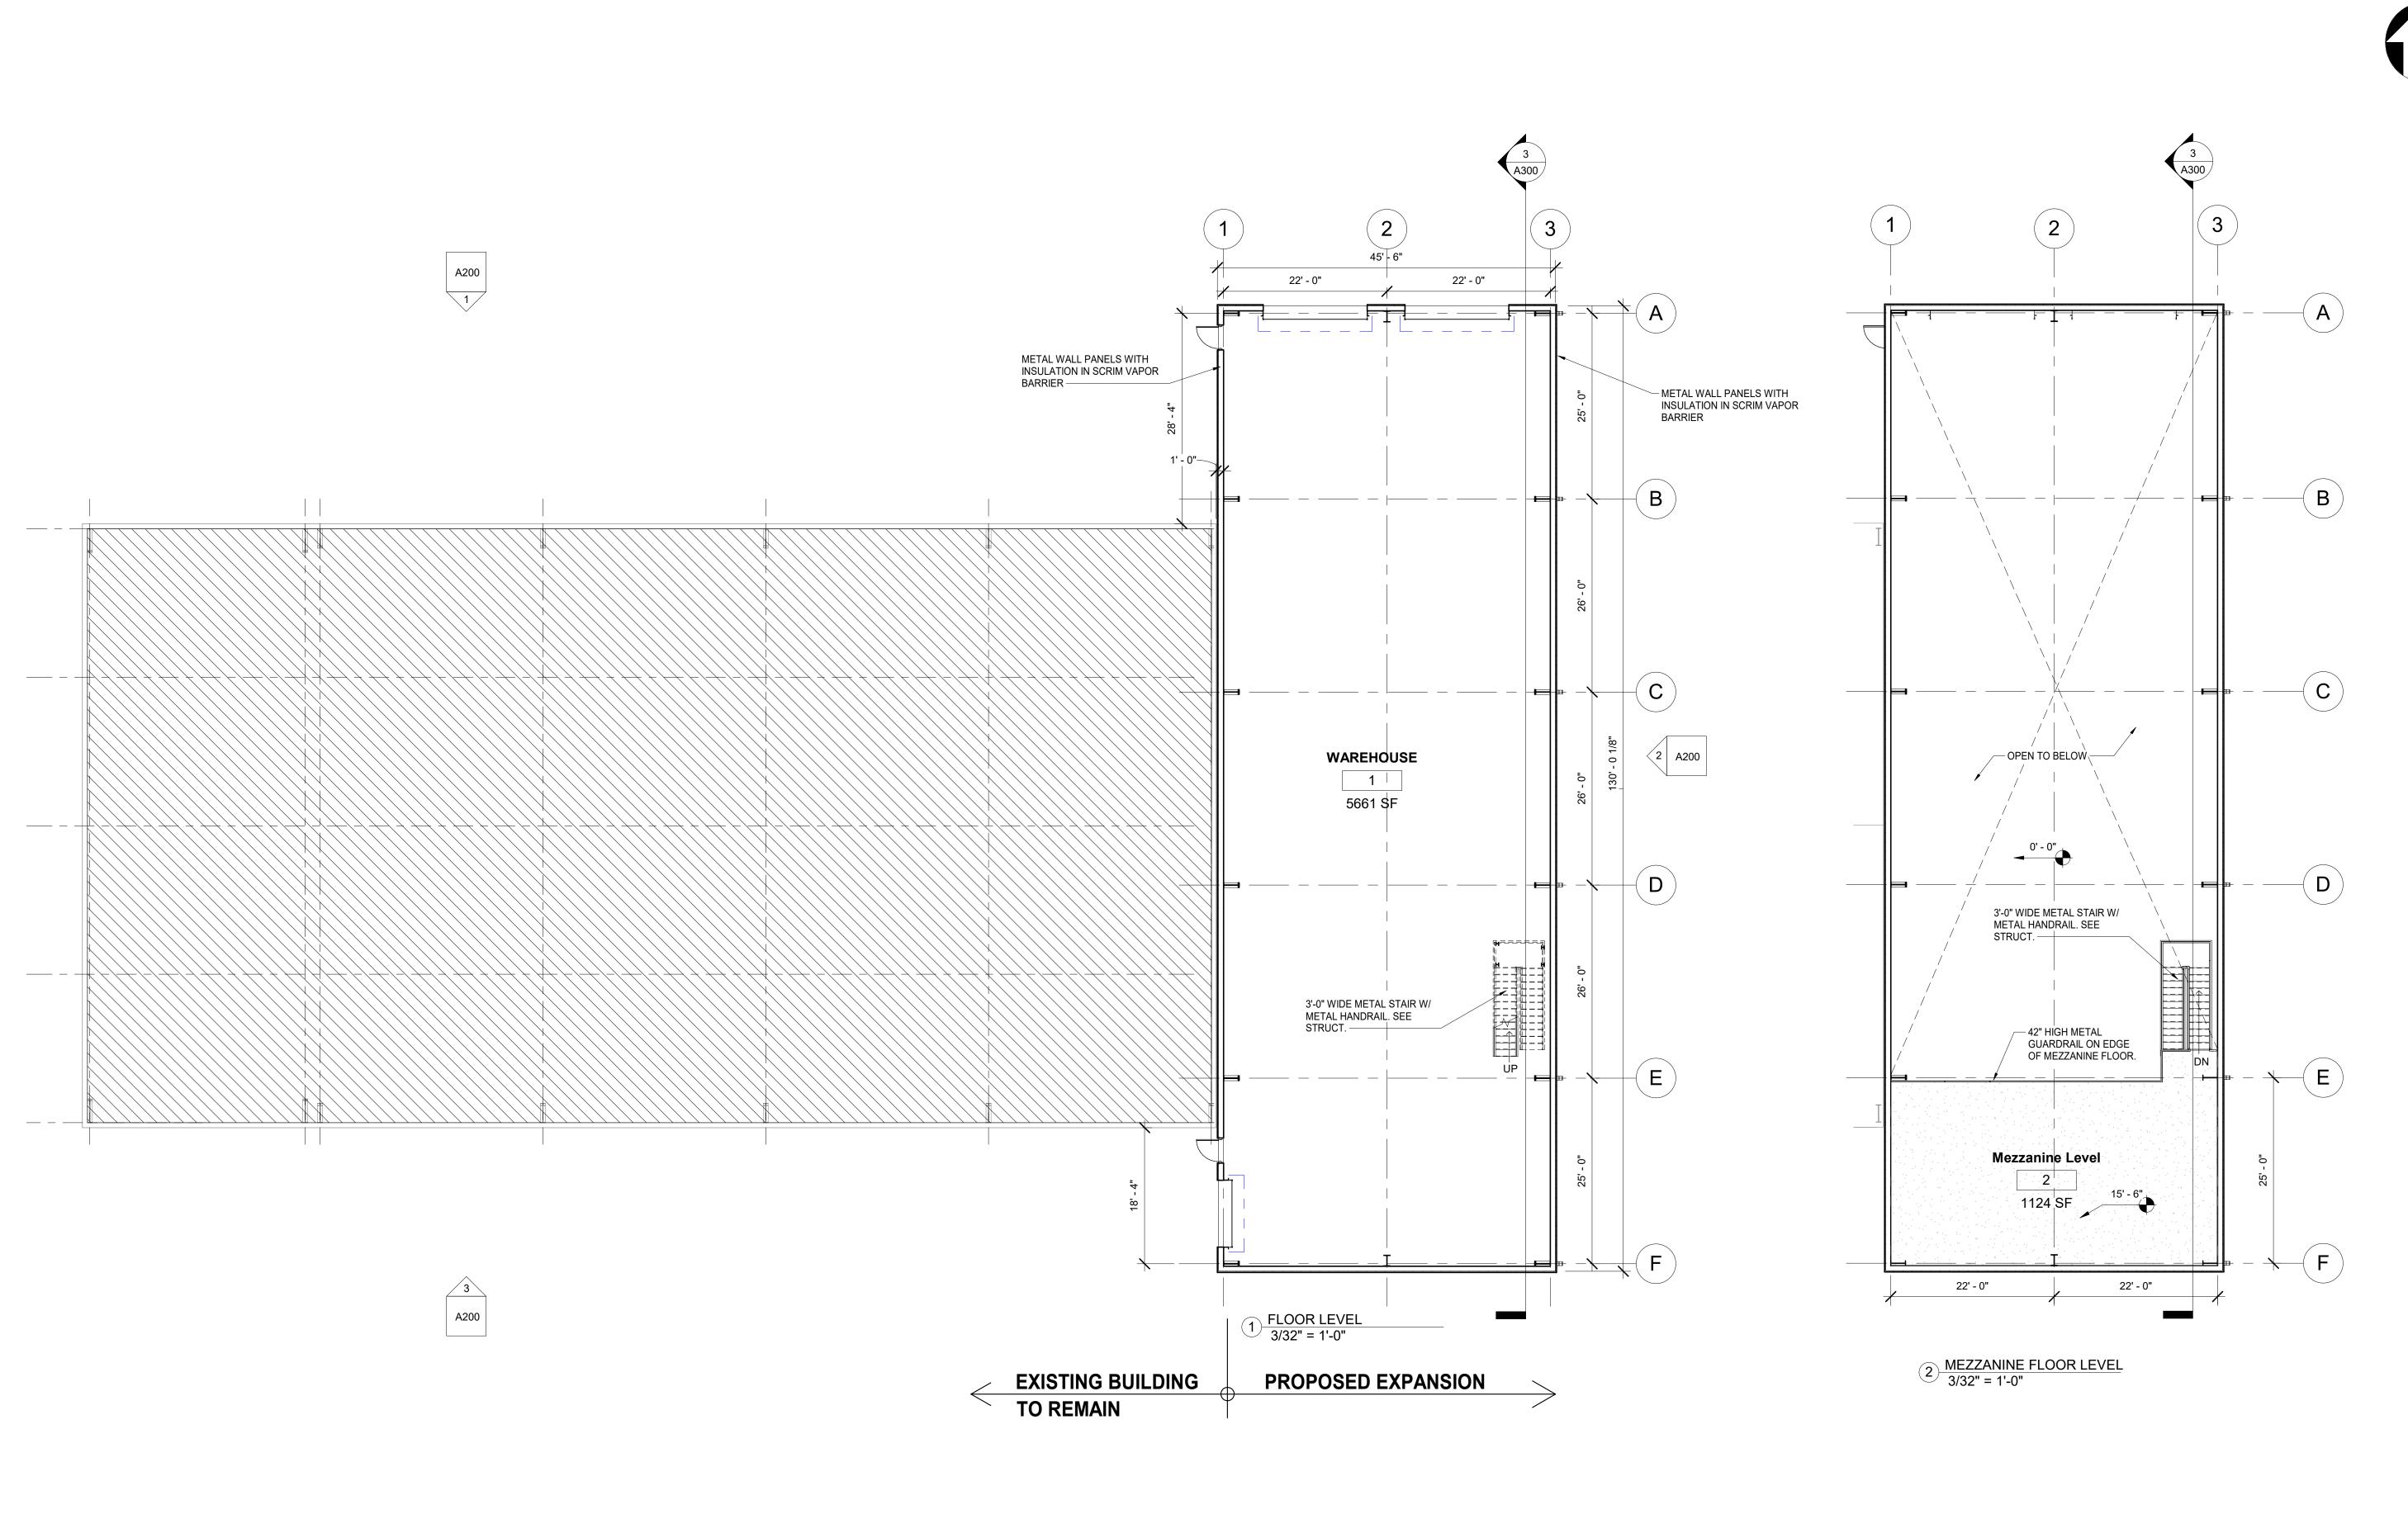

1620 DEAN FOREST, LLC BUILDING EXPANSION

**ARCHITECTURE** 

Consultant Address Address Phone Fax e-mail

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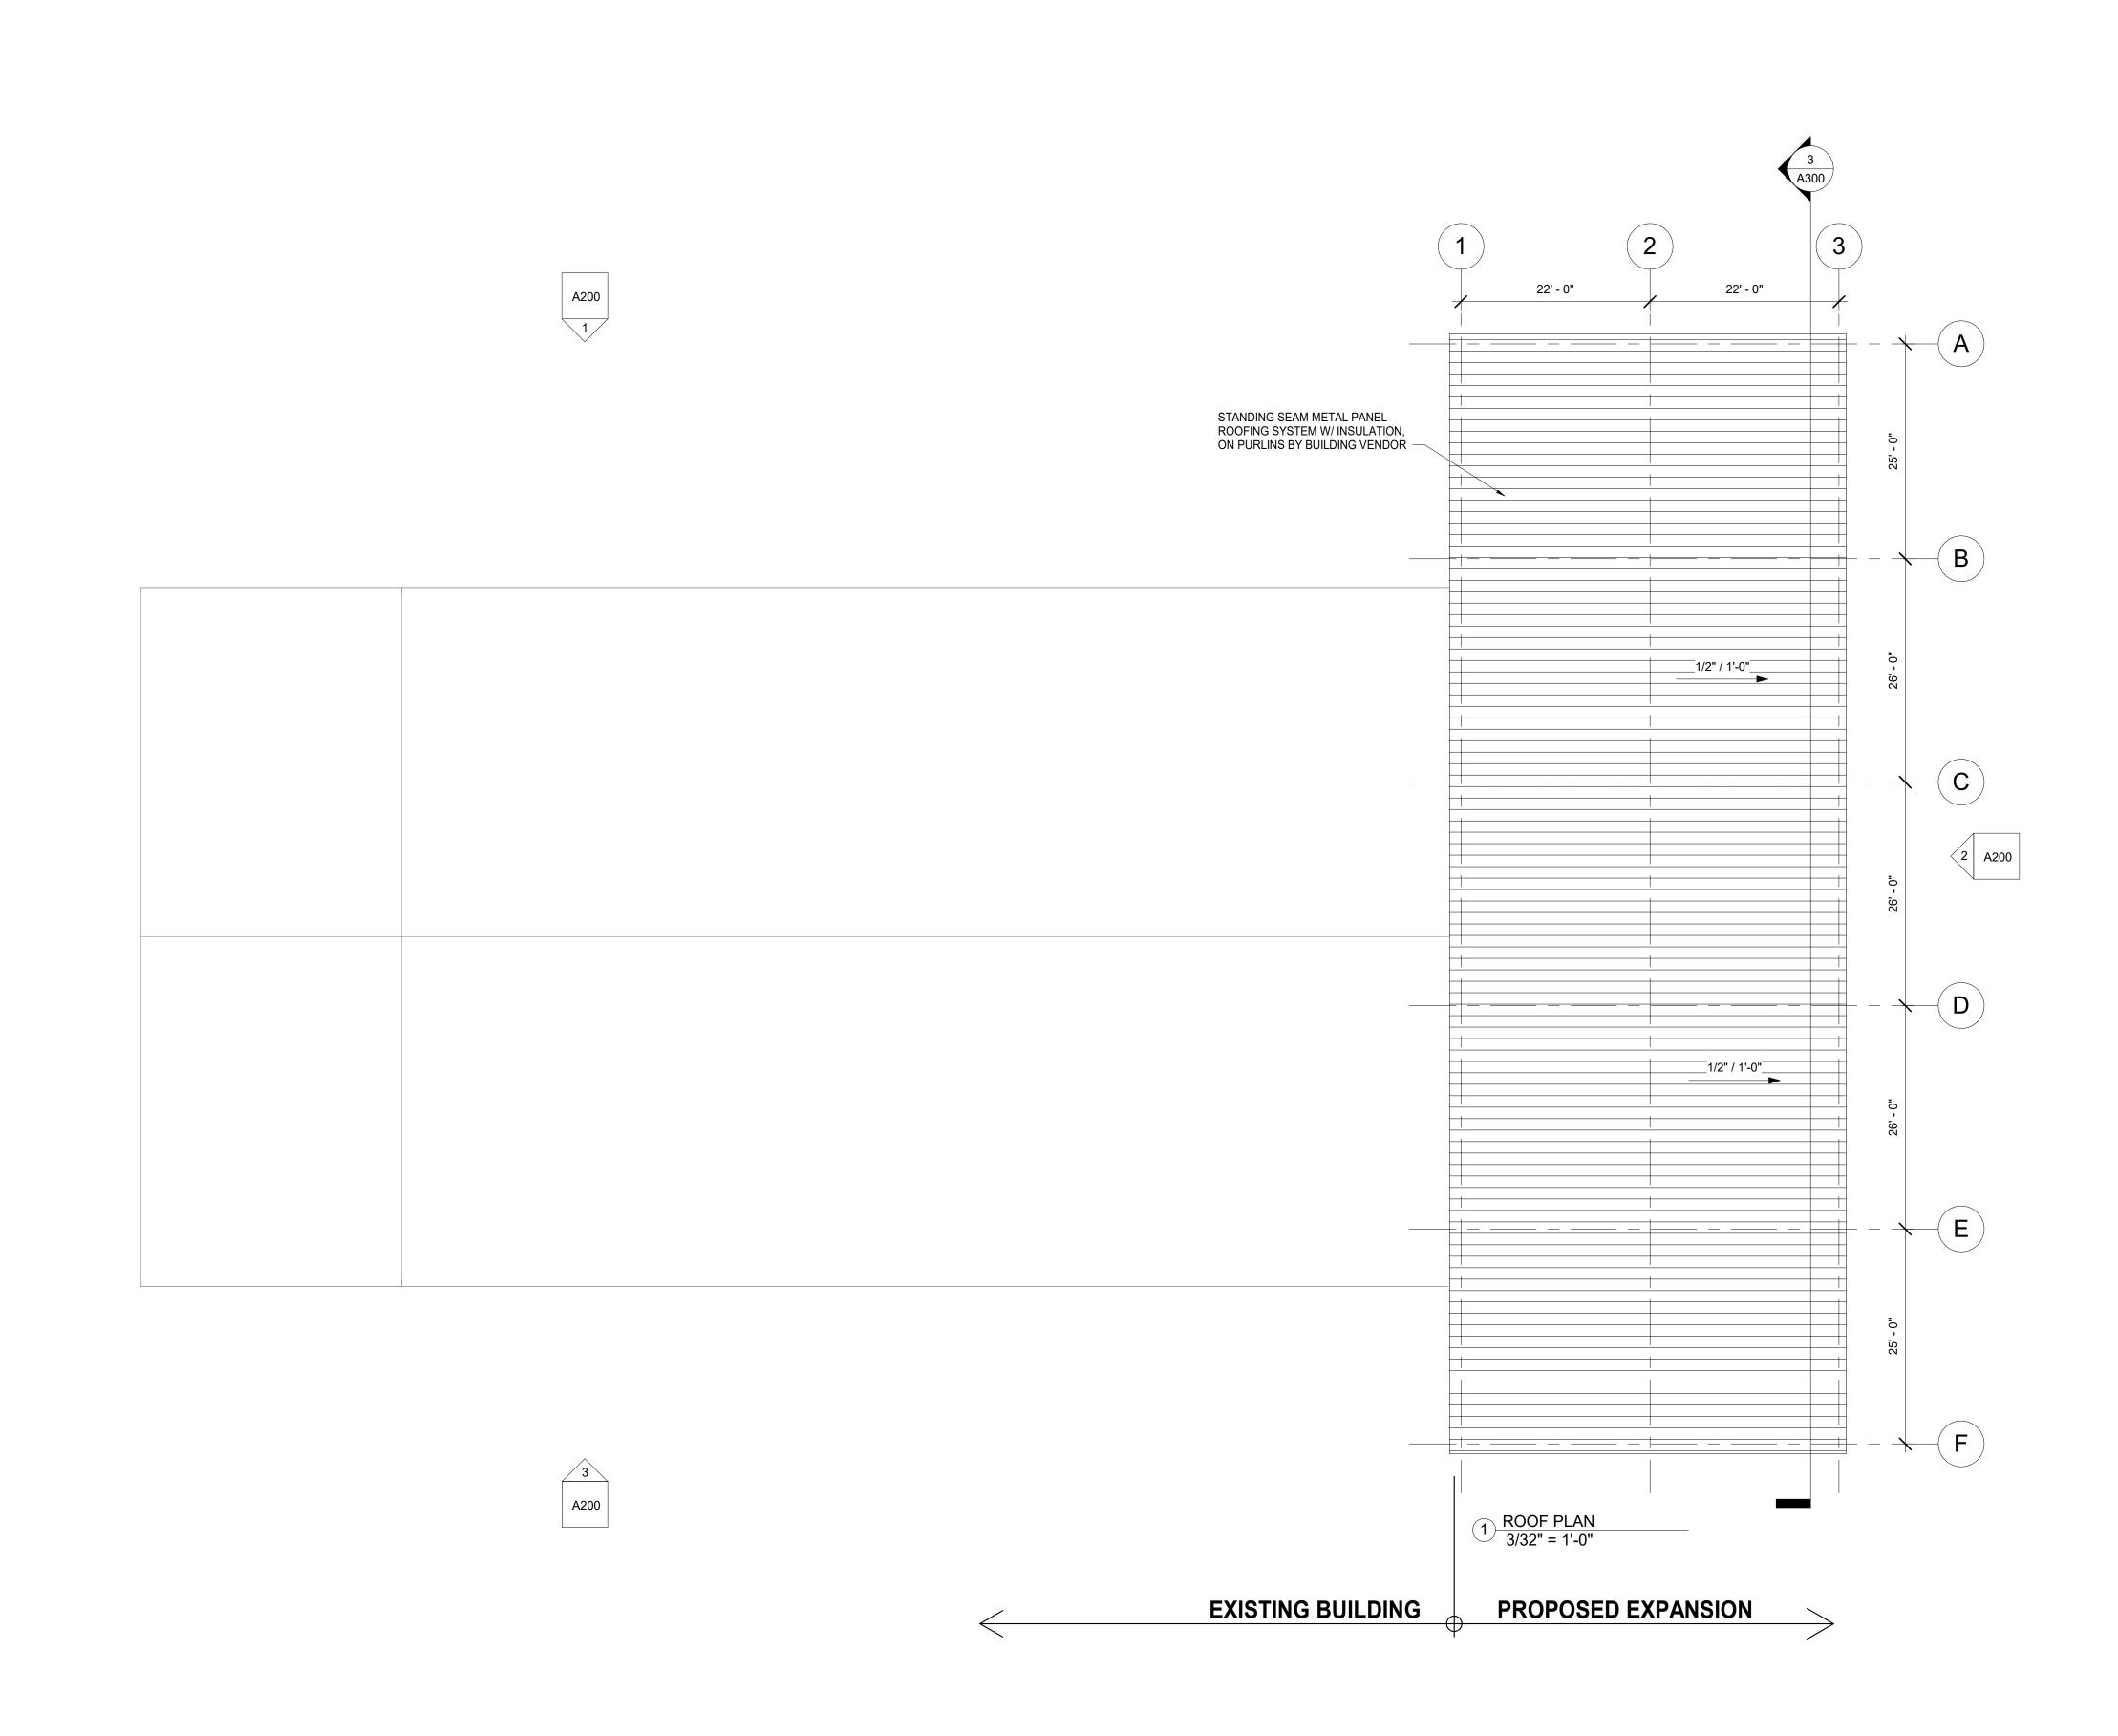
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Project # 000000000 03/04/23 ON

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FLOOR PLANS





1620 DEAN FOREST, LLC BUILDING EXPANSION

Project # 00000000

FOR REVIEW


A101

ROOF PLAN

ON

1620 Dean Forest Rd,

Consultant Address Address Phone Fax \_e-mail\_ SINCE DRAWINGS ARE FREQUENTLY PRINTED ON DIFFERENT SIZES OF PAPER, DO NOT SCALE FROM THESE DRAWINGS. USE THE GRAPHIC SCALE TO APPROXIMATE DISTANCE. SCALE AS NOTED IS FOR 24"X36" PRINT.

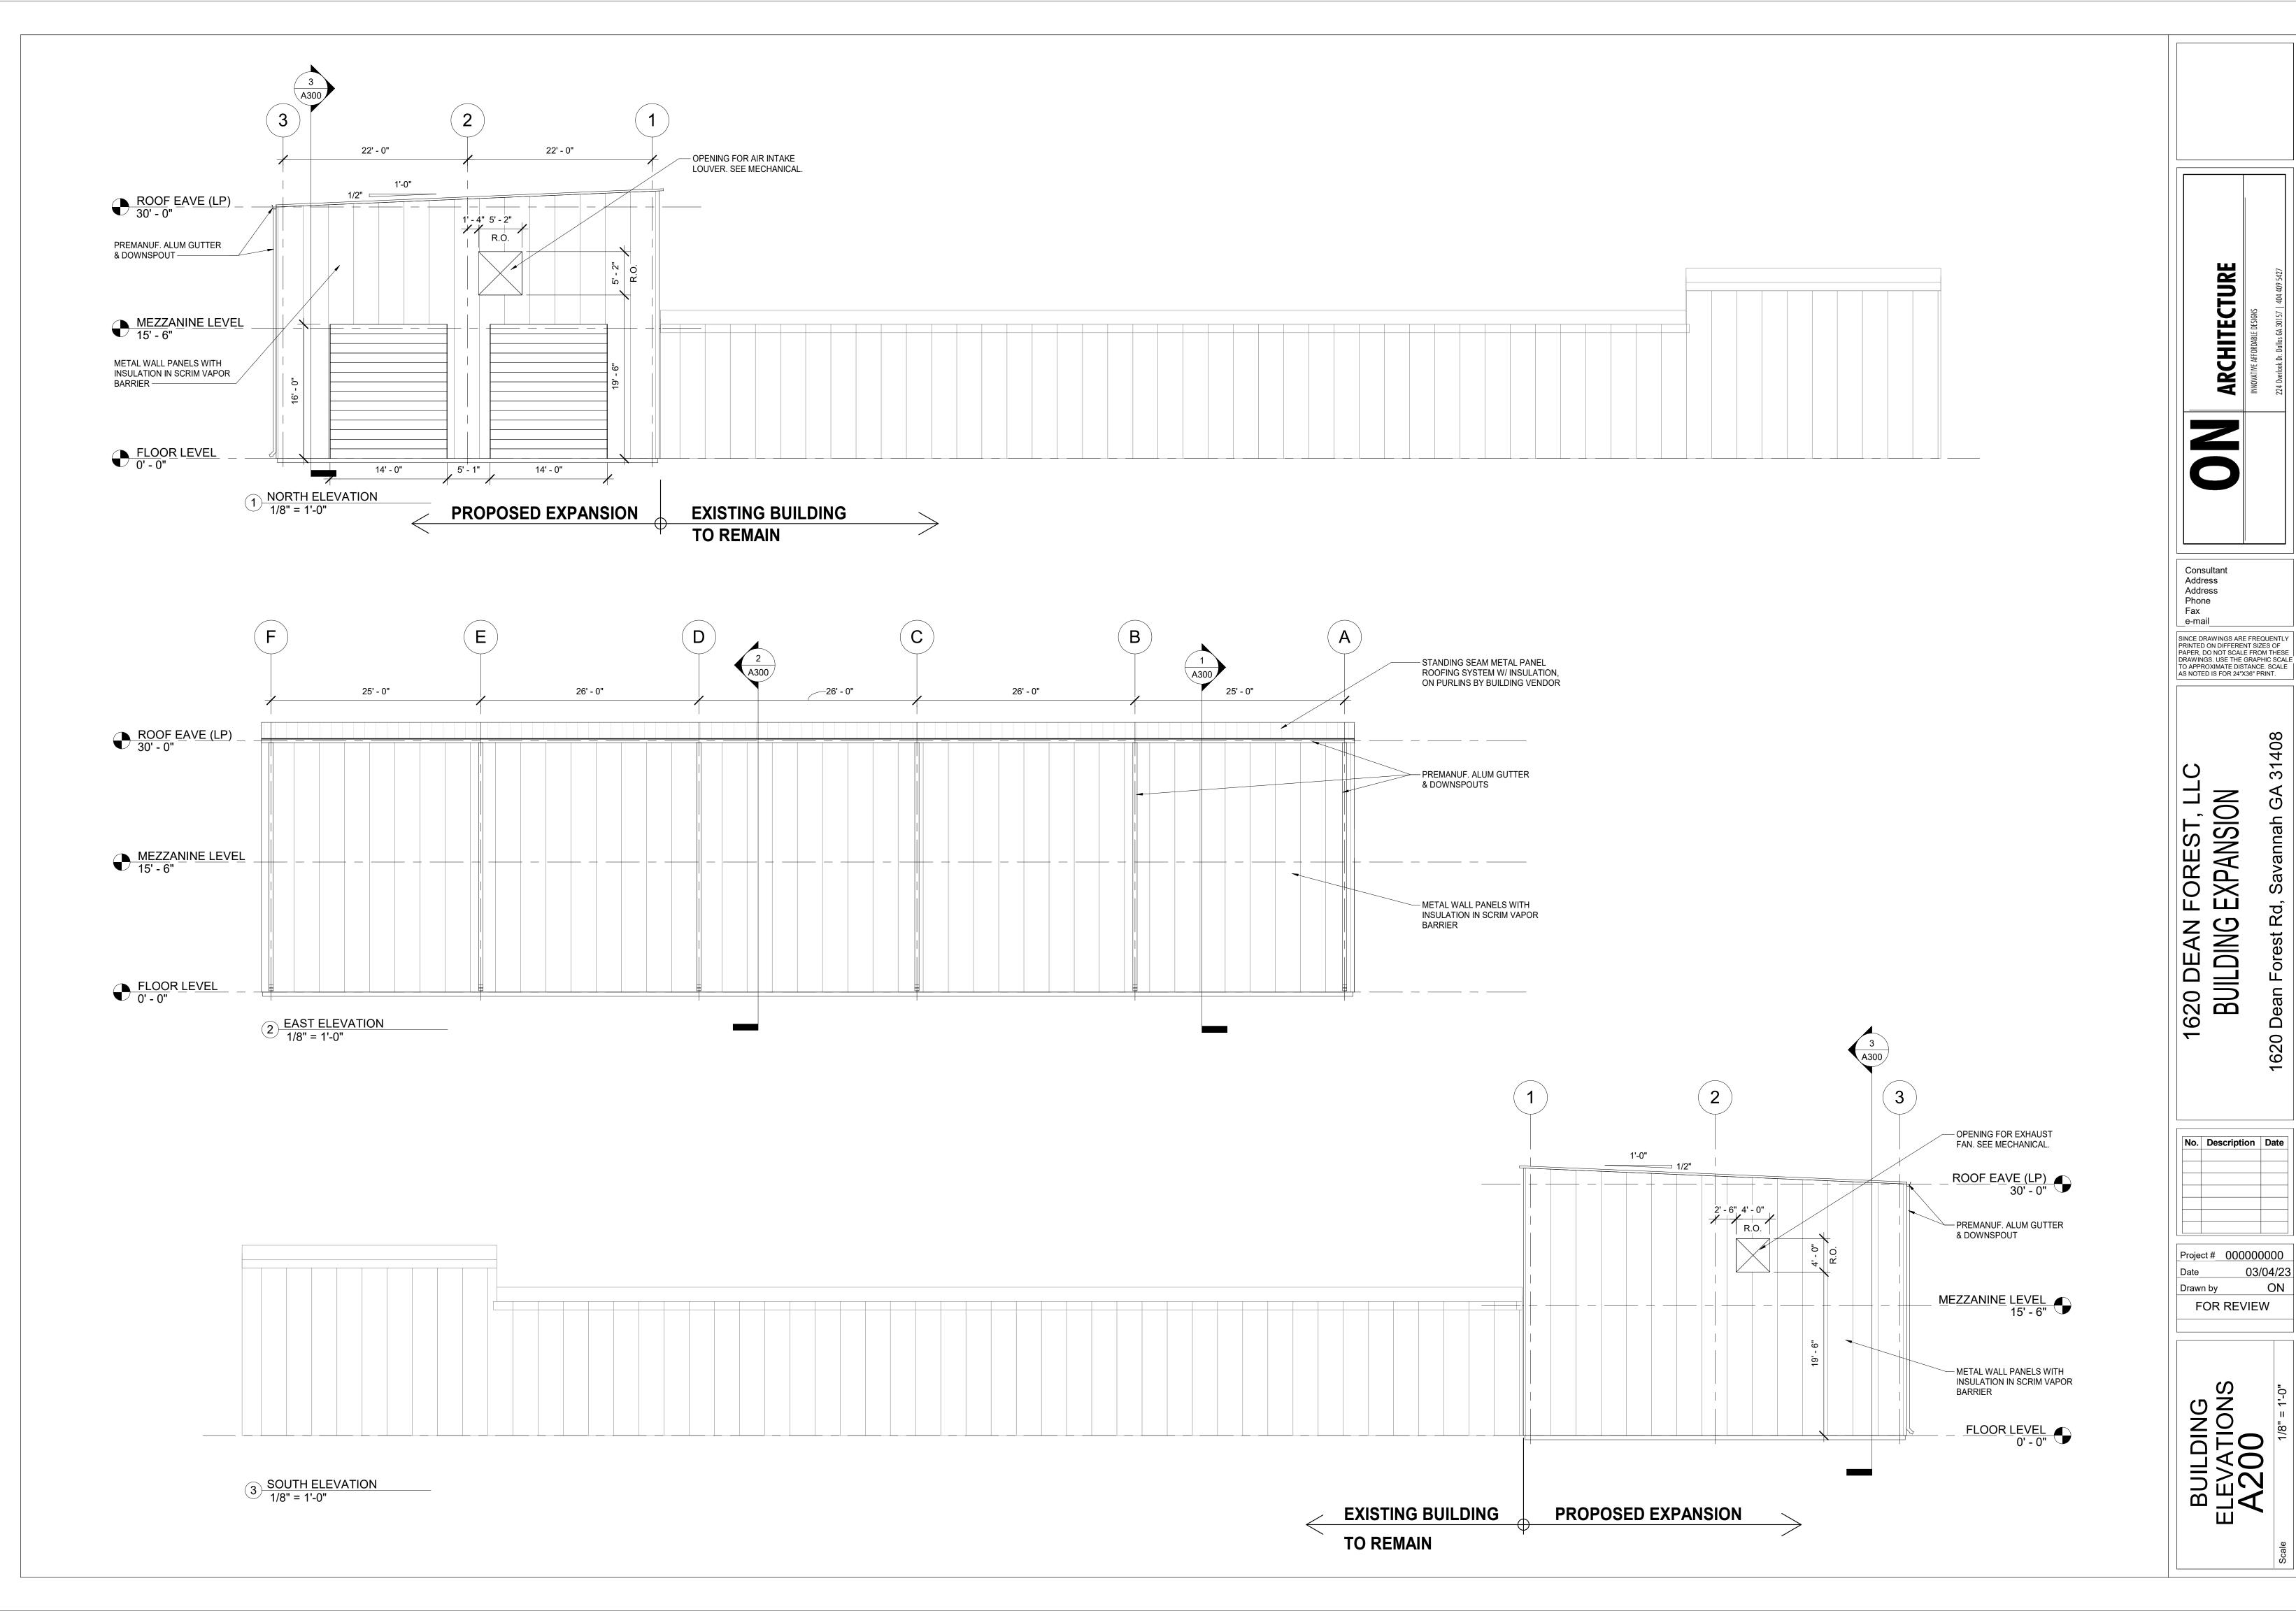

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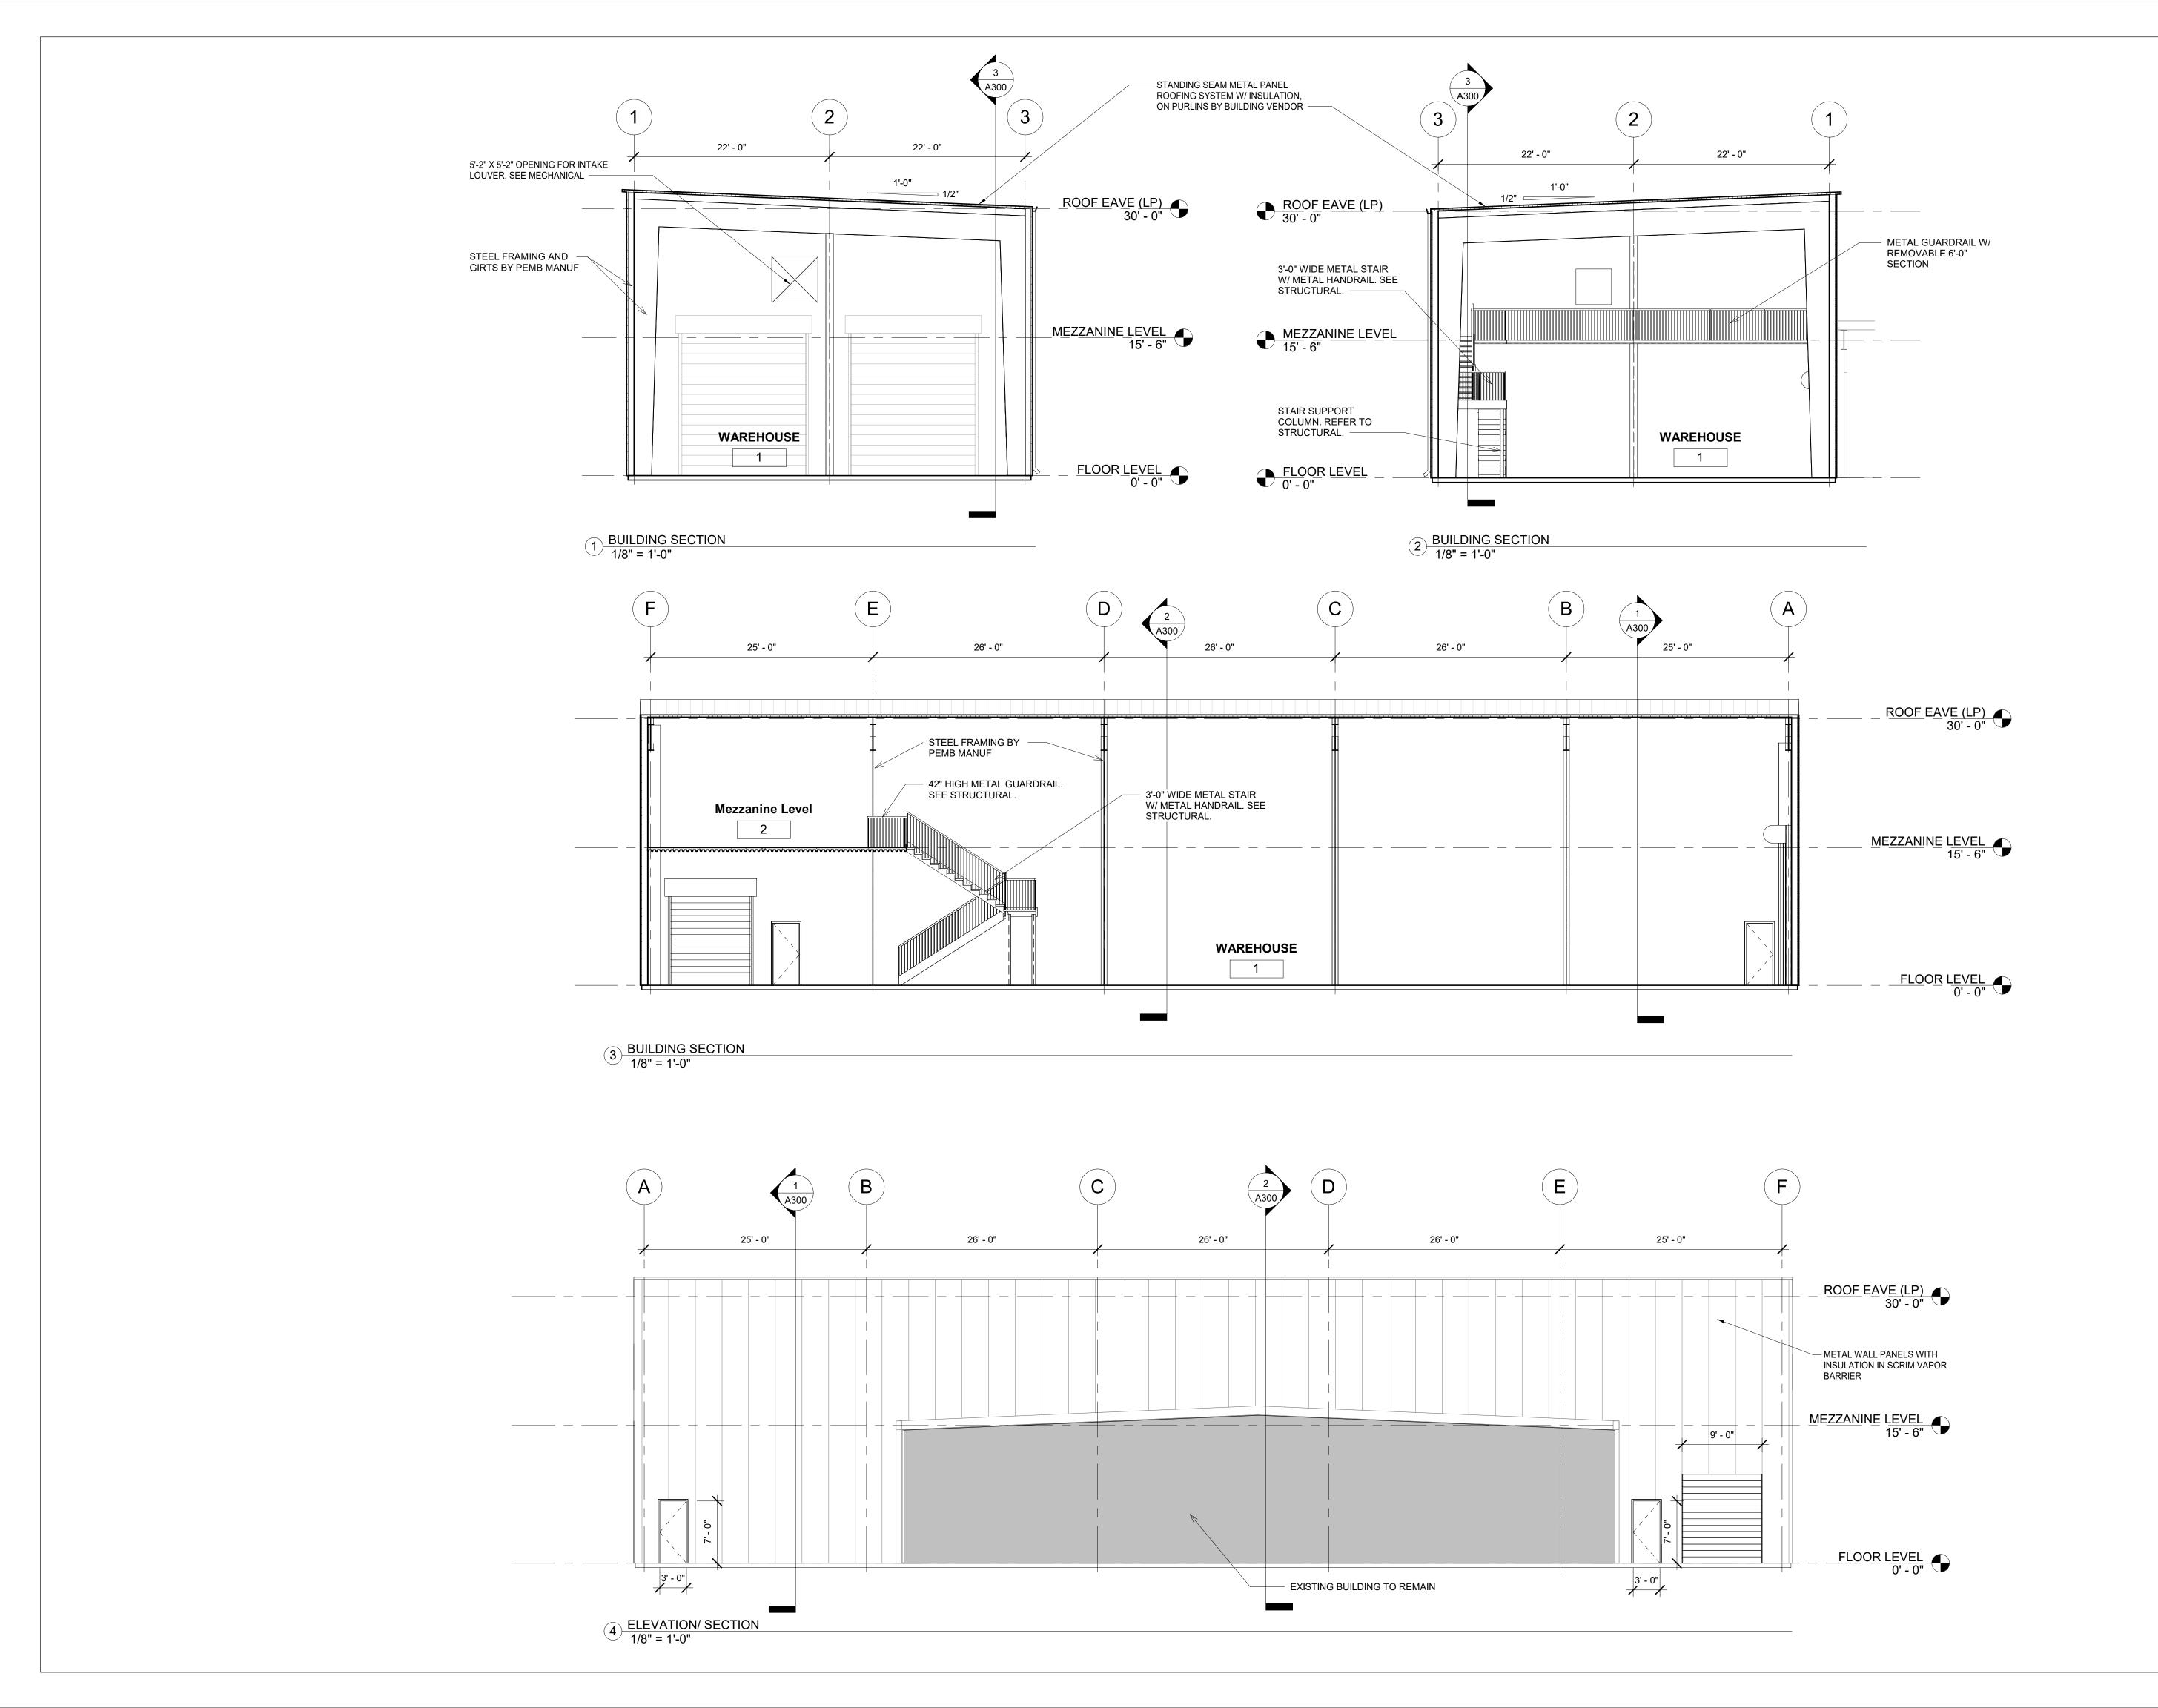
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Consultant Address Address Phone Fax e-mail

**ARCHITECTURE** 

Project # 000000000 03/04/23 ON Drawn by FOR REVIEW BUILDING ELEVATIONS A200



1620 DEAN FOREST, LI BUILDING EXPANSION

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BUILDING SECTIONS A300

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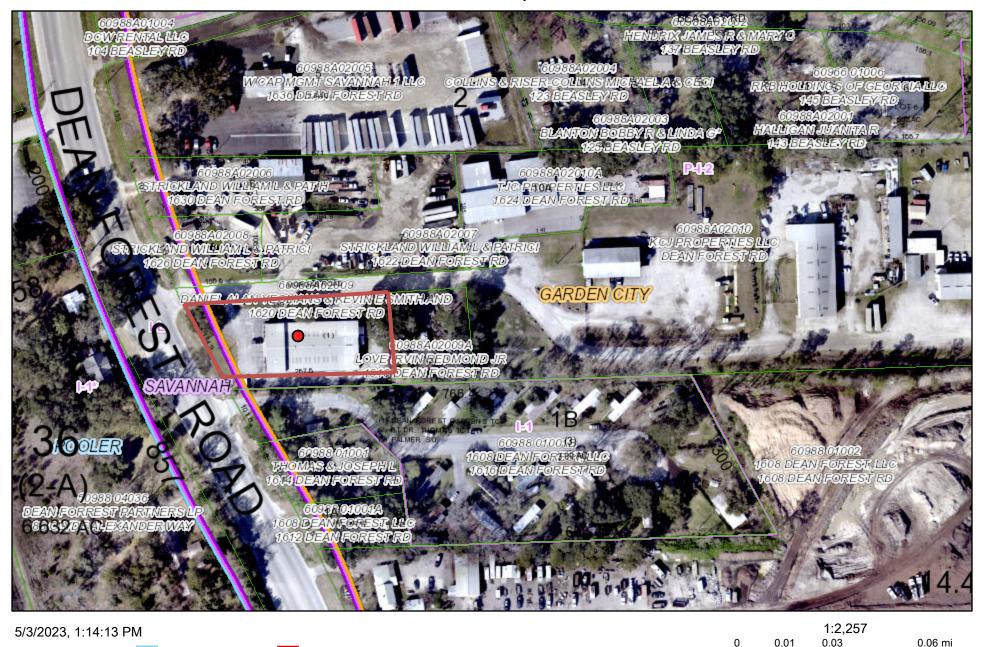
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#### PC2320: General Development Plan Review



UNINCORPORATED

Owner, PIN and Address Labels

Zoning

THUNDERBOLT

■ VERNONBURG

Municipal Boundary

POOLER

GARDEN CITY SAVANNAH

BLOOMINGDALE PORT WENTWORTH TYBEE ISLAND



0.1 km

0.06 mi

0.03

SAGIS

0.05